

# Olney Library Addition & Renovation Mandatory Referral Review 3500 Olney-Laytonsville Road Olney, Maryland 20832

Owner- Project Management Section, Division of Building Design & Construction Department of General Services 101 Monroe Street, 11th Floor Rockville, MD, 20850

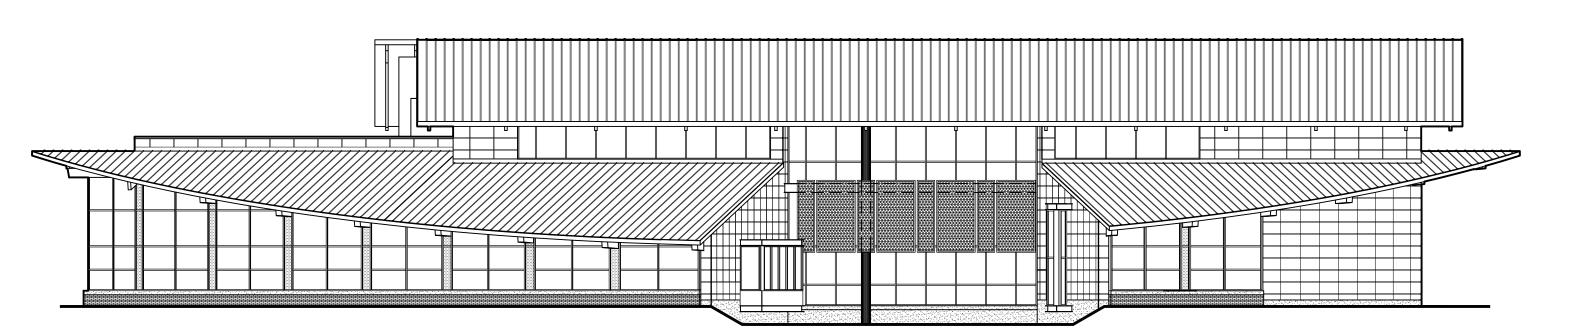

SHEET LIST **BUILDING DATA CODE SUMMARY** NO DATE ISSUE DESCRIPTION GENERAL:
G-001 TITLE SHEET PROJECT DESCRIPTION: APPLICABLE CODES: See G-101 Addition & Renovation to Olney Library CIVIL AND LANDSCAPE: C-1 EXISTING CONDITIONS PLAN **BUILDING AREA:** BUILDING OCCUPANCY: See G-101 C-2 SITE PLAN C-0C PEDESTRIAN & VEHICULAR CIRCULATION PLAN 20,226 GSF CONSTRUCTION TYPE: TYPE II B FIRST FLOOR MECHANICAL MEZZ. 2,328 GSF L-1.01 COMBINED NRI / FSD & TREE SAVE PLAN THE BUILDING SHALL BE FULLY SPRINKLERED IN COMPLIANCE 22,544 GSF WITH SECTION 903.3.1.1 AND NFPA 13 SPRINKLER CODE L-1.02 COMBINED NRI / FSD & TREE SAVE NOTES & DETAILS L-2.0 LANDSCAPE PLANTING PLAN L-2.1 LANDSCAPE NOTES AND DETAILS ALLOWABLE BUILDING AREA: L-2.2 STORM WATER PLANTING PLAN 114,000 SF ARCHITECTURAL:
A-101 FIRST FLOOR PLAN ACTUAL BUILDING AREA: 20, 226 SF A-104 ROOF PLAN A-201 BUILDING ELEVATIONS ALLOWABLE BUILDING HEIGHT: A-202 BUILDING ELEVATIONS 75'-0" SF A-203 BUILDING ELEVATIONS **ACTUAL BUILDING HEIGHT:** A-1101 FURNITURE PLAN 44'-4" SF ELECTRICAL: E-401 SITE PLAN BUILDING OCCUPANT LOADS: SEE SHEET G101 E-402 SITE PLAN-PHOTOMETRICS \*SEE SHEET G101 FOR DETAILED CODE ANALYSIS PROJECT TEAM **VICINITY MAP** KEY PLAN: The Lukmire Partnership, Inc. 2700 South Quincy Street, Suite 300 Arlington, Virginia, 22206 703-998 0101 Civil Engineers The Studio of Sandra Ragan ADTEK Engineers 97 Monocacy Blvd, Unit H Washington, D.C., 20008 Frederick, Maryland 21701 202-363-0105 301-622-4408 Structural Engineers: Columbia Engineering 6210 Old Dobbin Lane, Suite 150 Columbia Maryland, 21045 410-992-9970 Mechanical, Electrical & Plumbing Mendoza Ribas Farinas & Associates 6265 Executive Boulevard Rockville, Maryland, 20852 301-468-8882

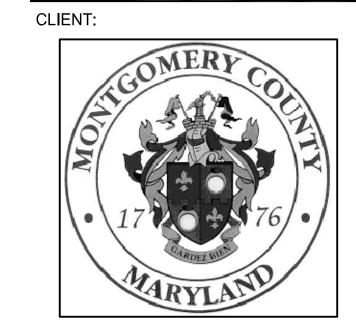

#### **MONTGOMERY COUNTY MARYLAND**

Division of Building Design and

**Olney Library Addition & Renovation Design** Development

Olney, Maryland 20832 PROJECT NO.: Client Proj. No

The Lukmire Partnership, Inc. Architecture Planning Interiors



ARLINGTON, VA 22206 www.lukmire.com

architect under the laws of the State of Maryland, license number\_\_\_\_, expiration date

REGISTRATION:


NO.	DATE	ISSUE DESCRIPTION
1	11-18-2009	DD SUBMISSION
2	12-11-2009	MR REVIEW
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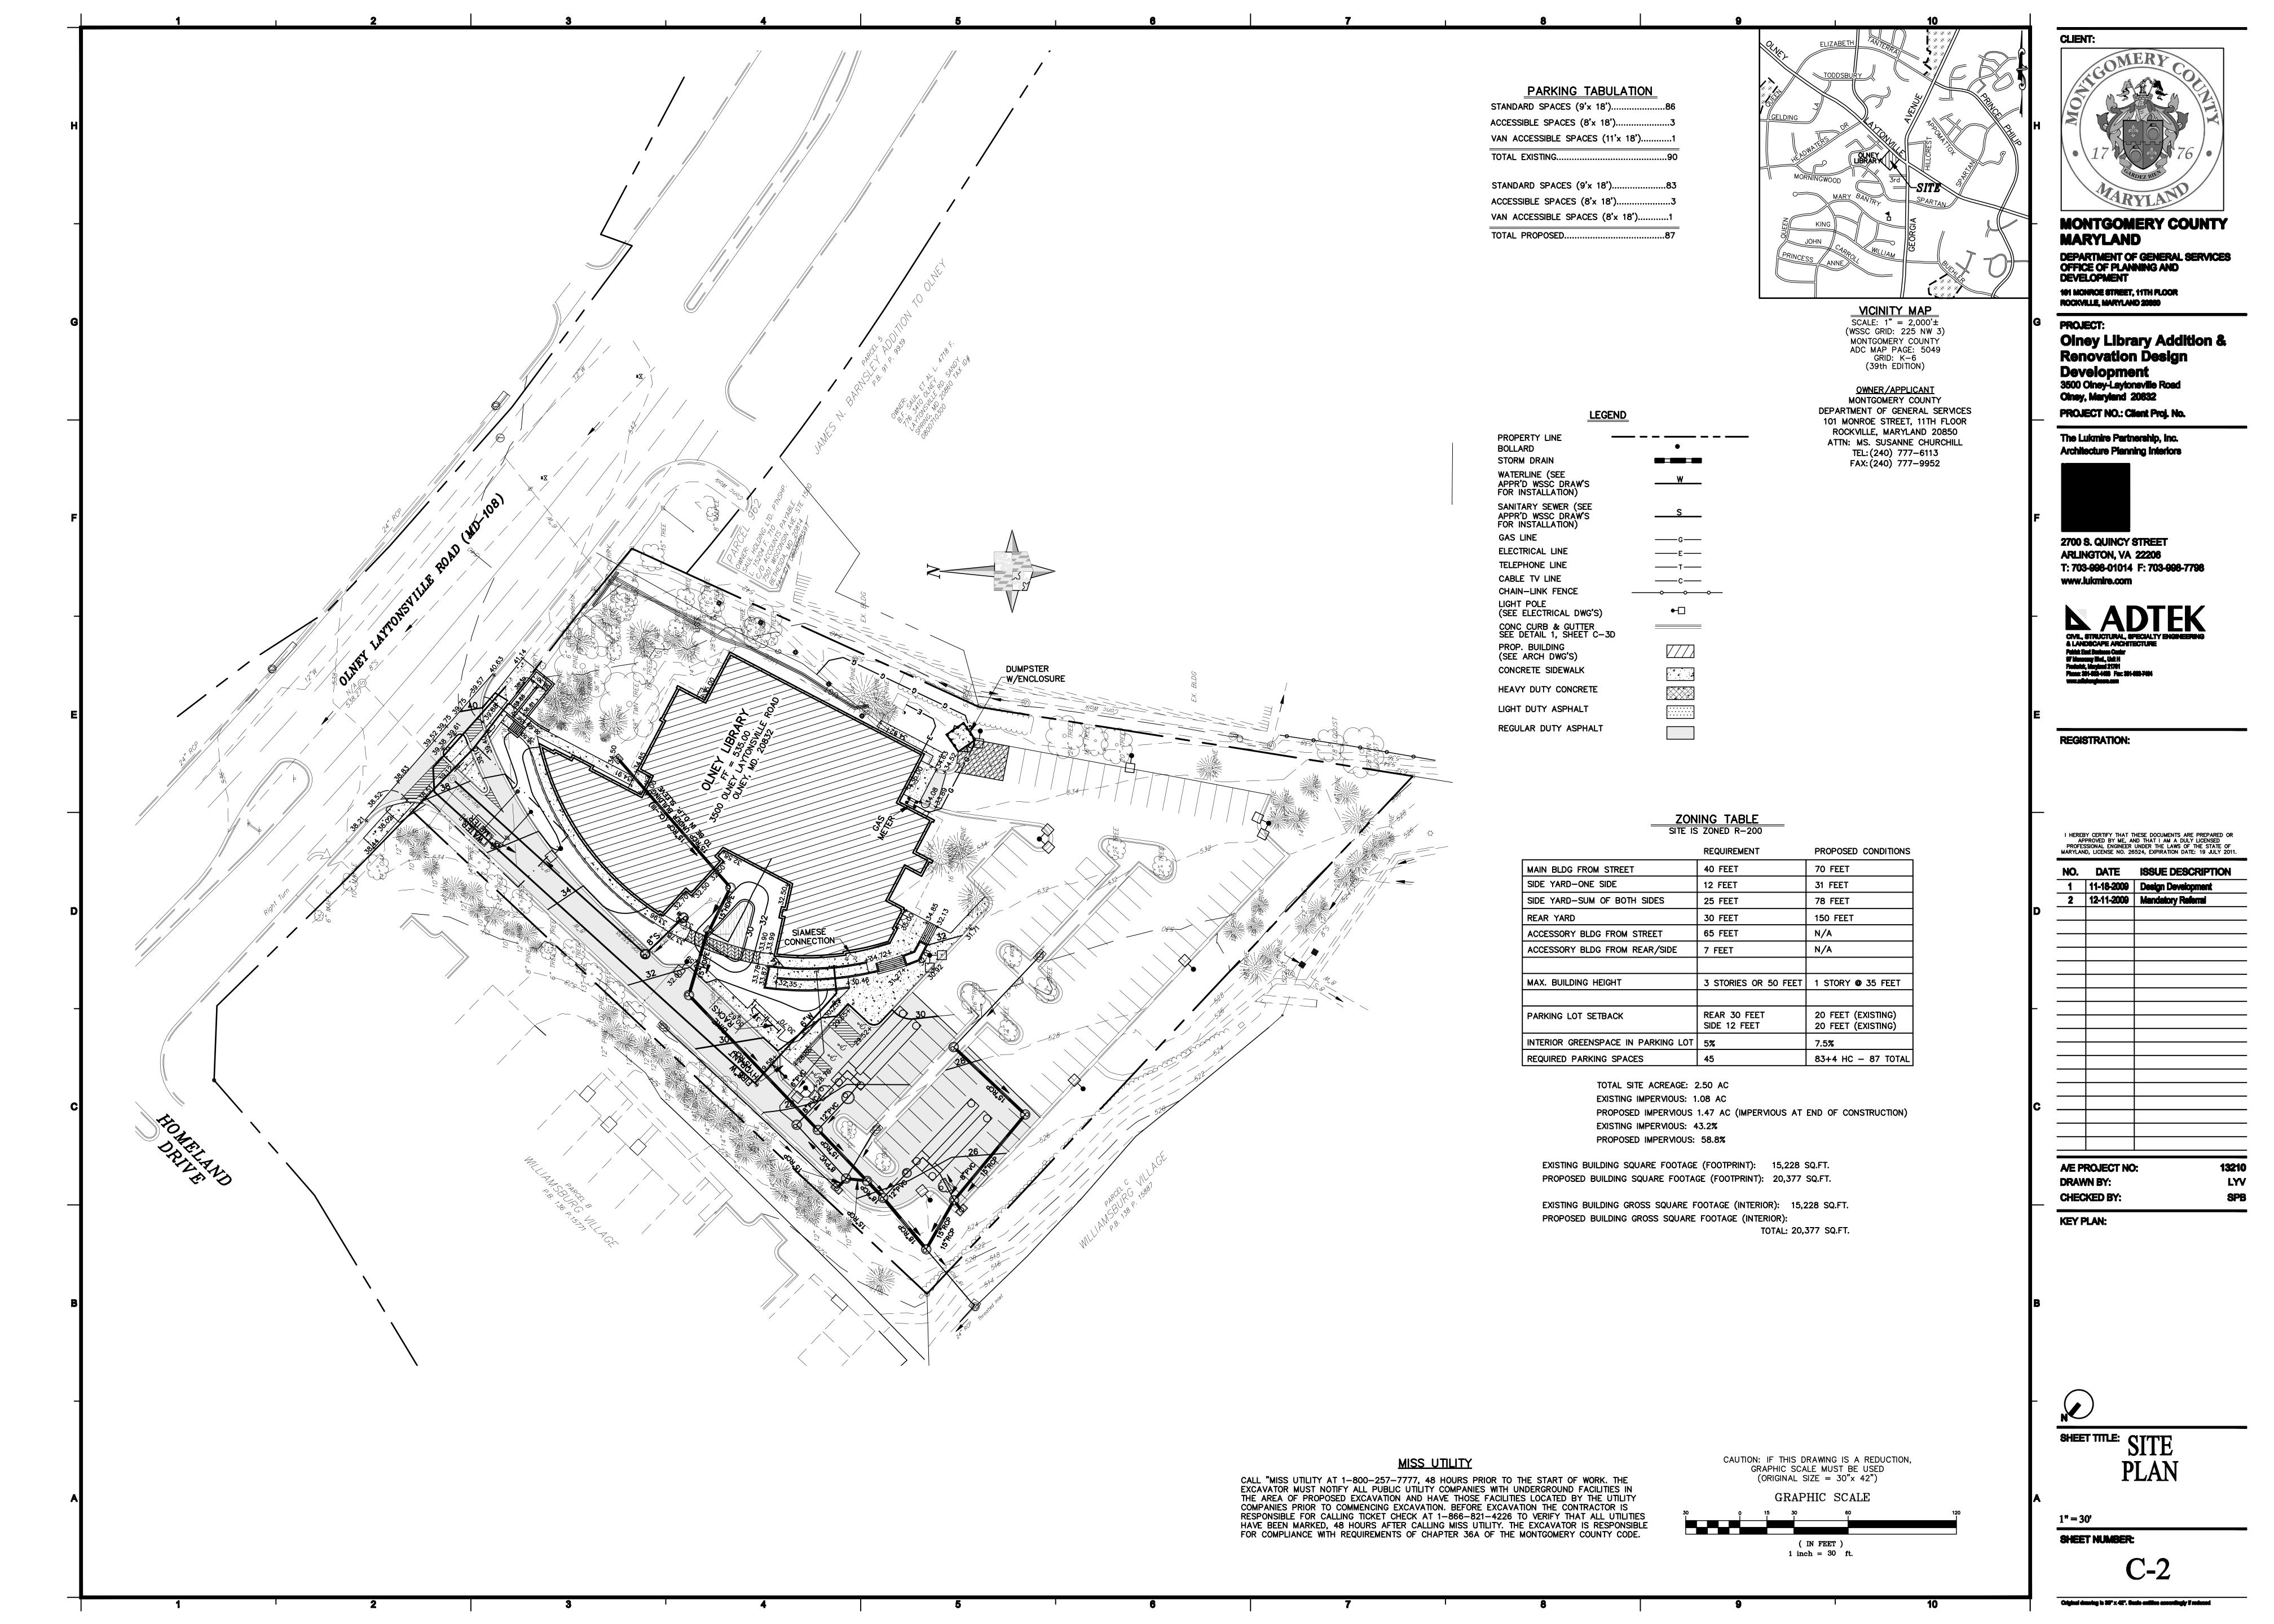
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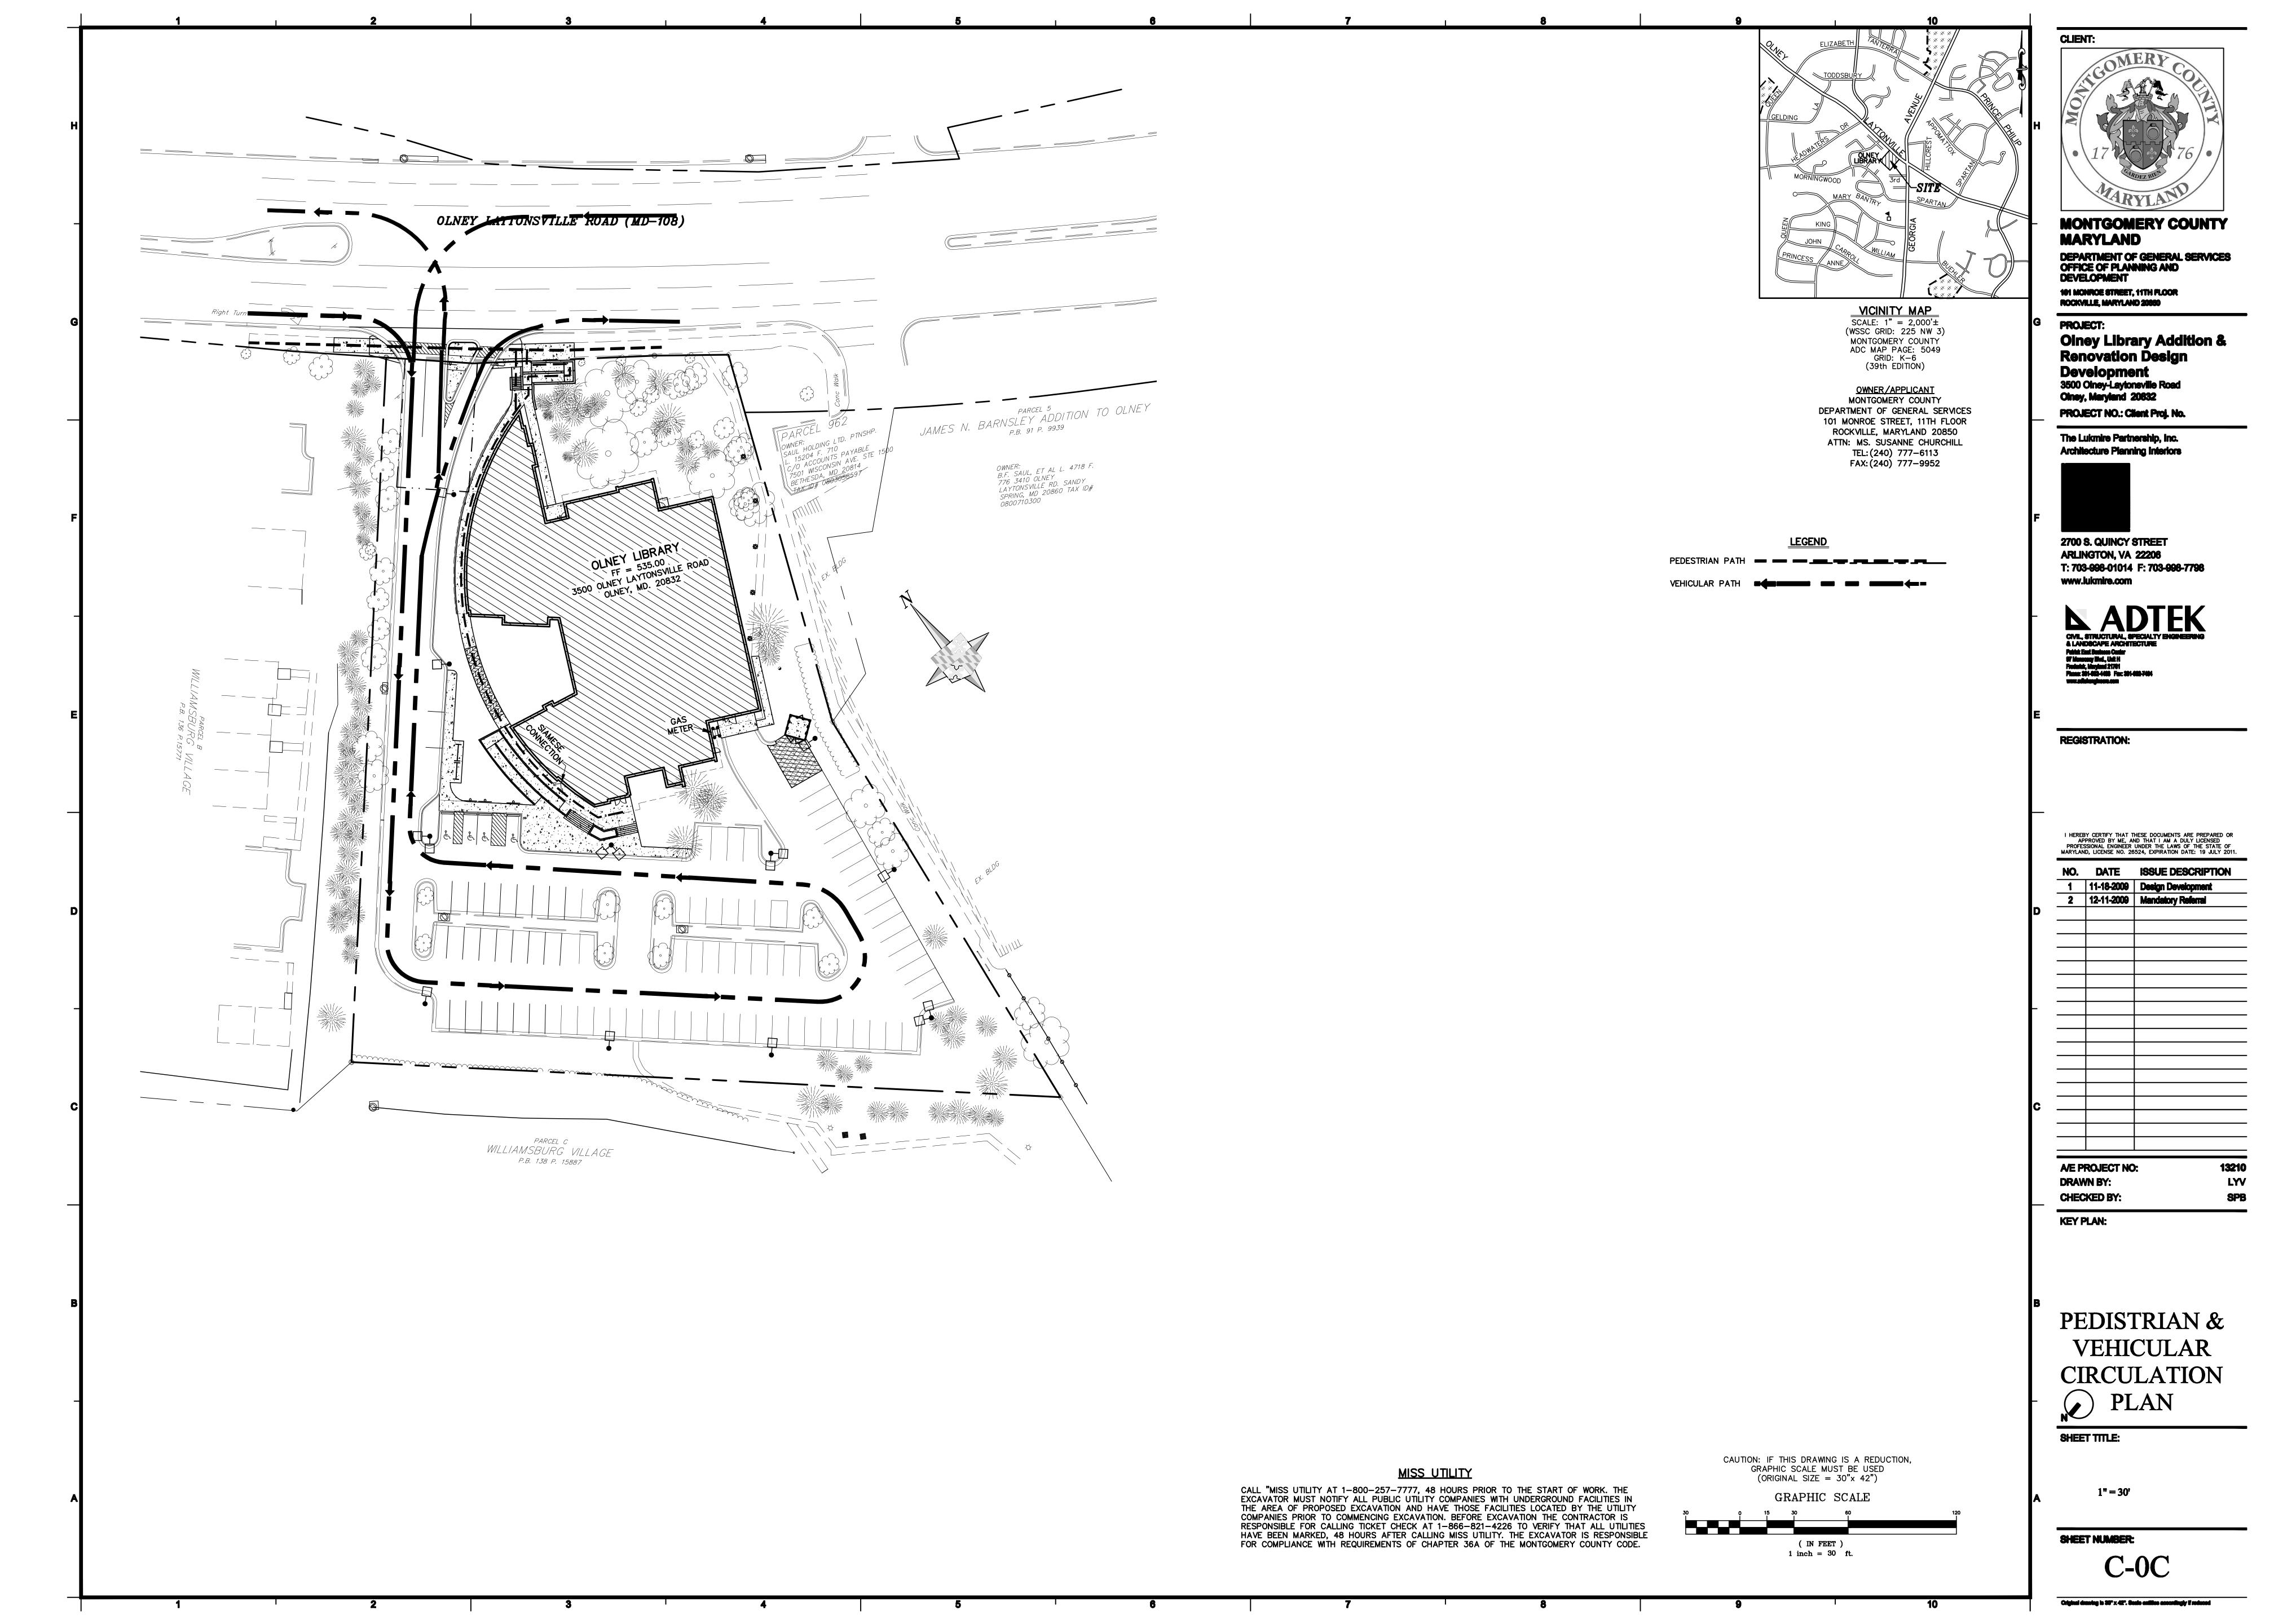
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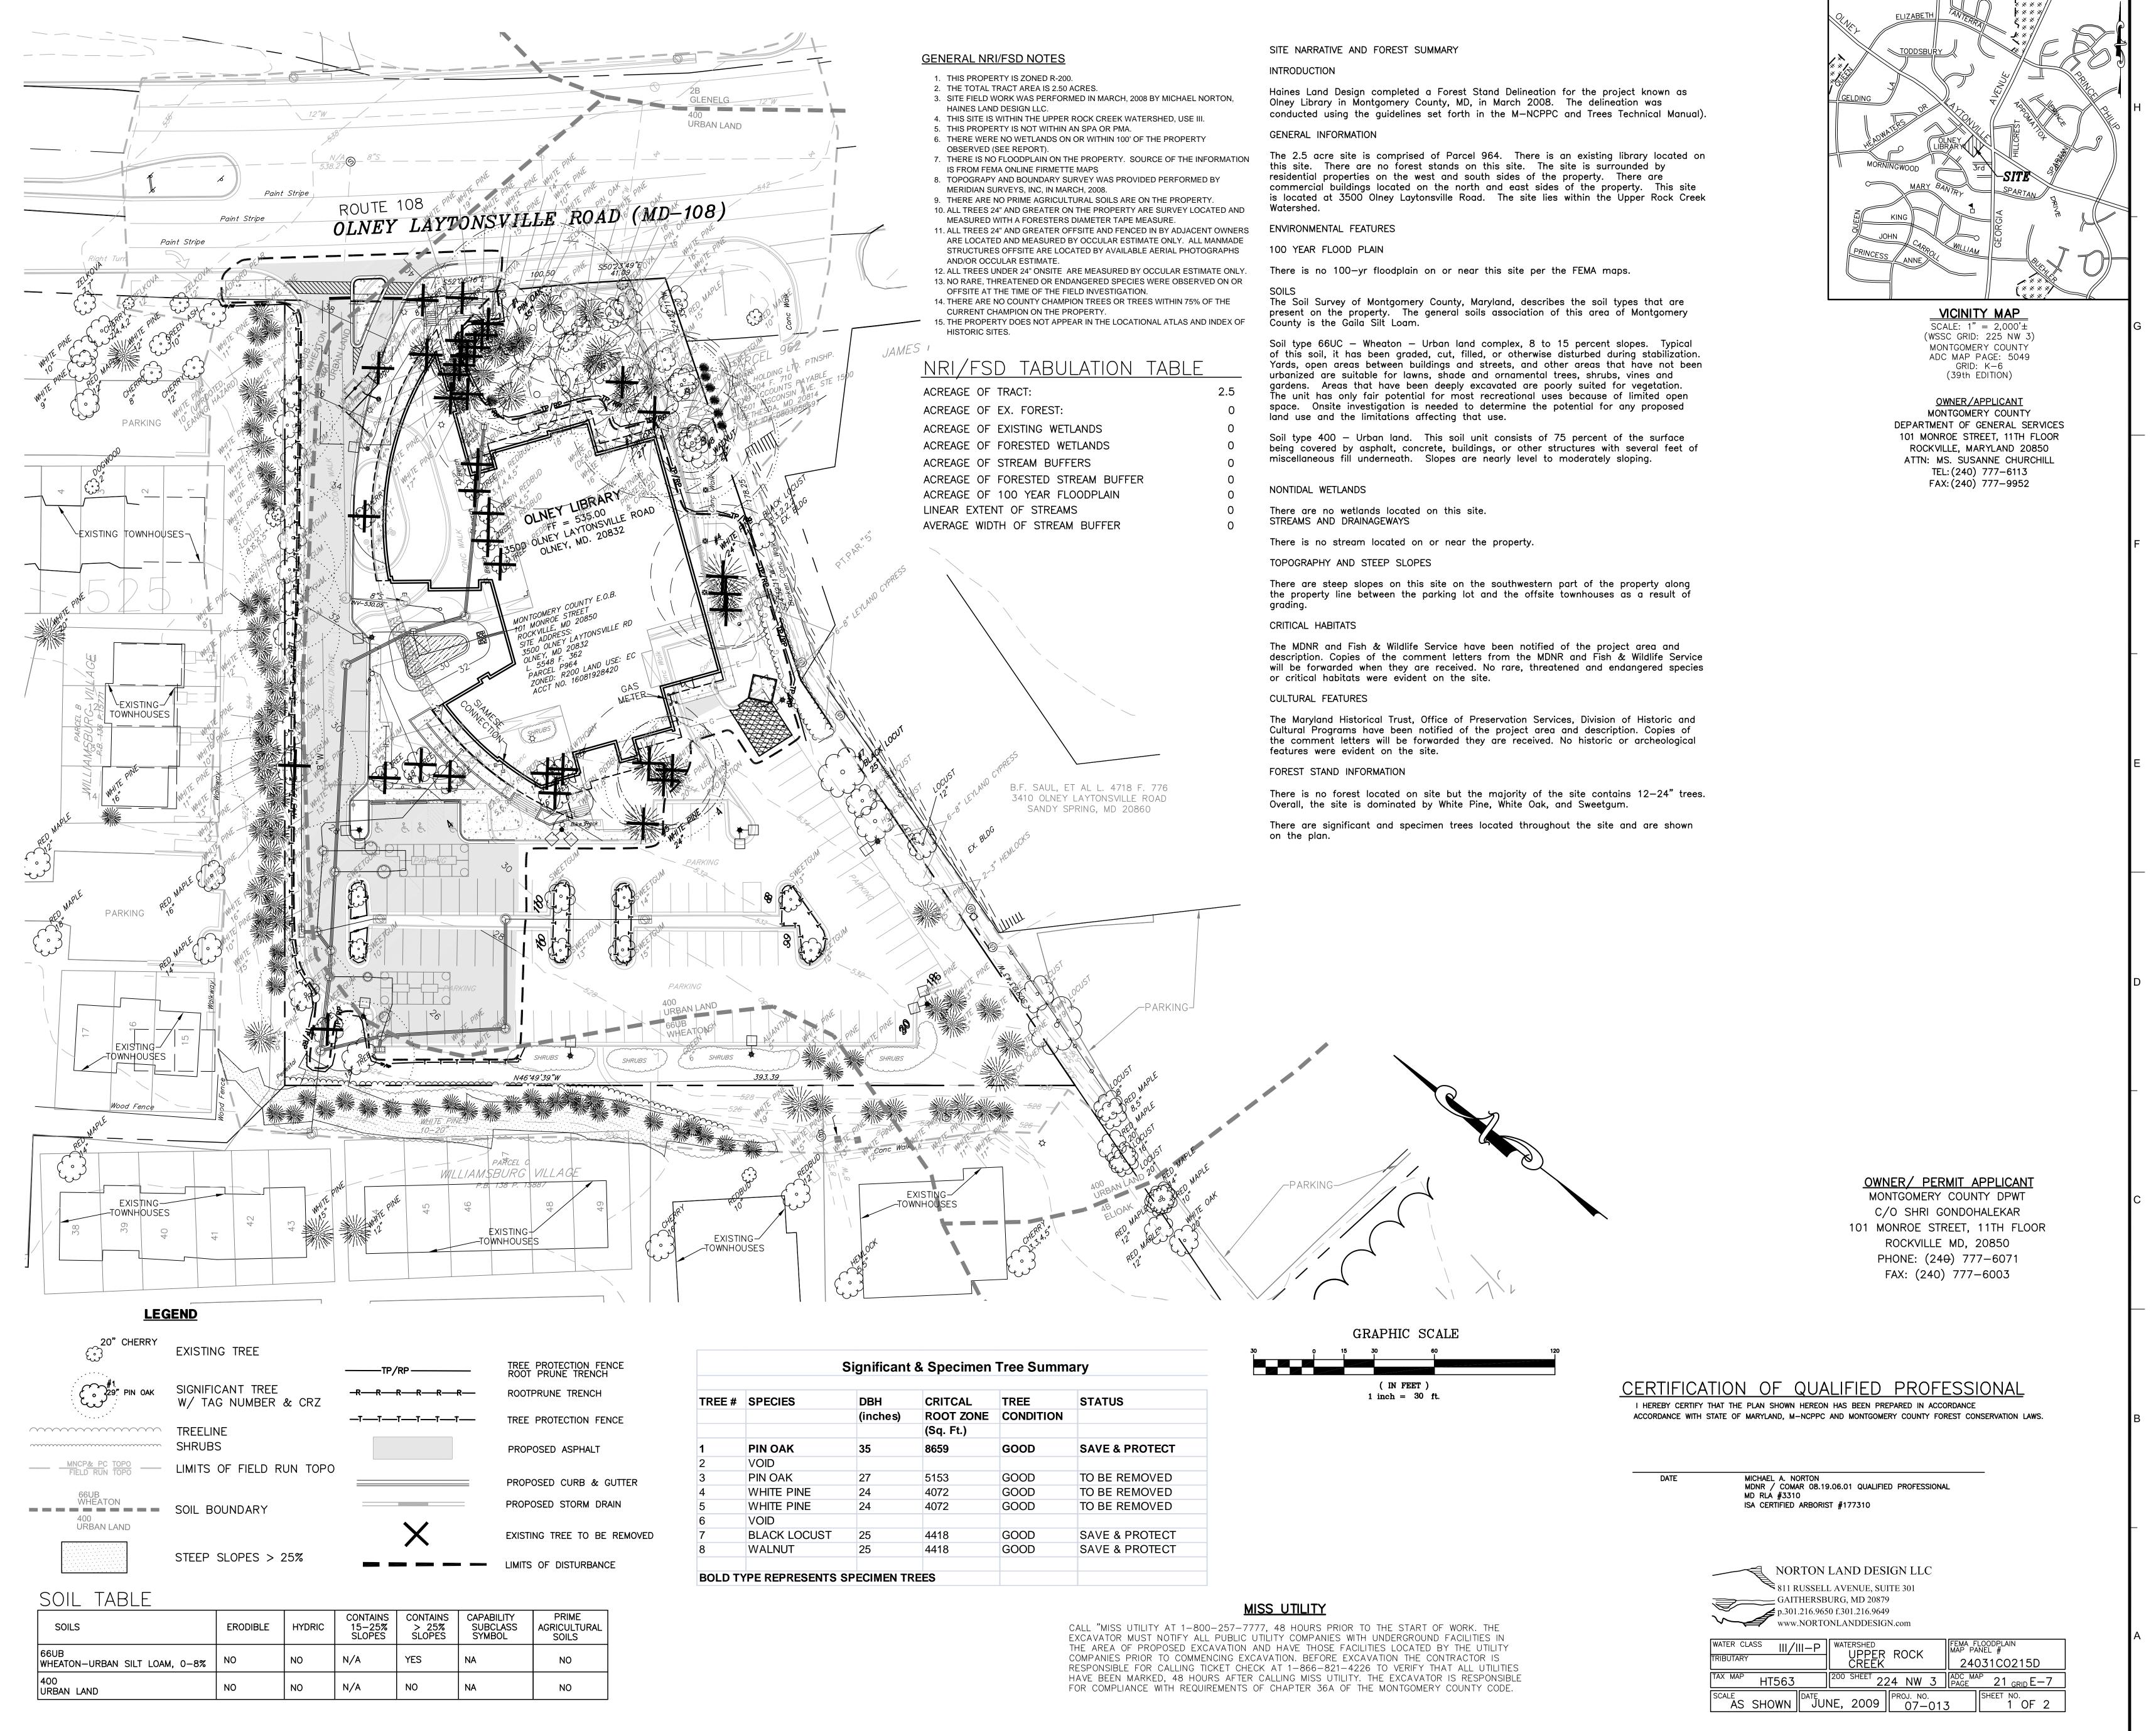
SHEET NUMBER:

G-001







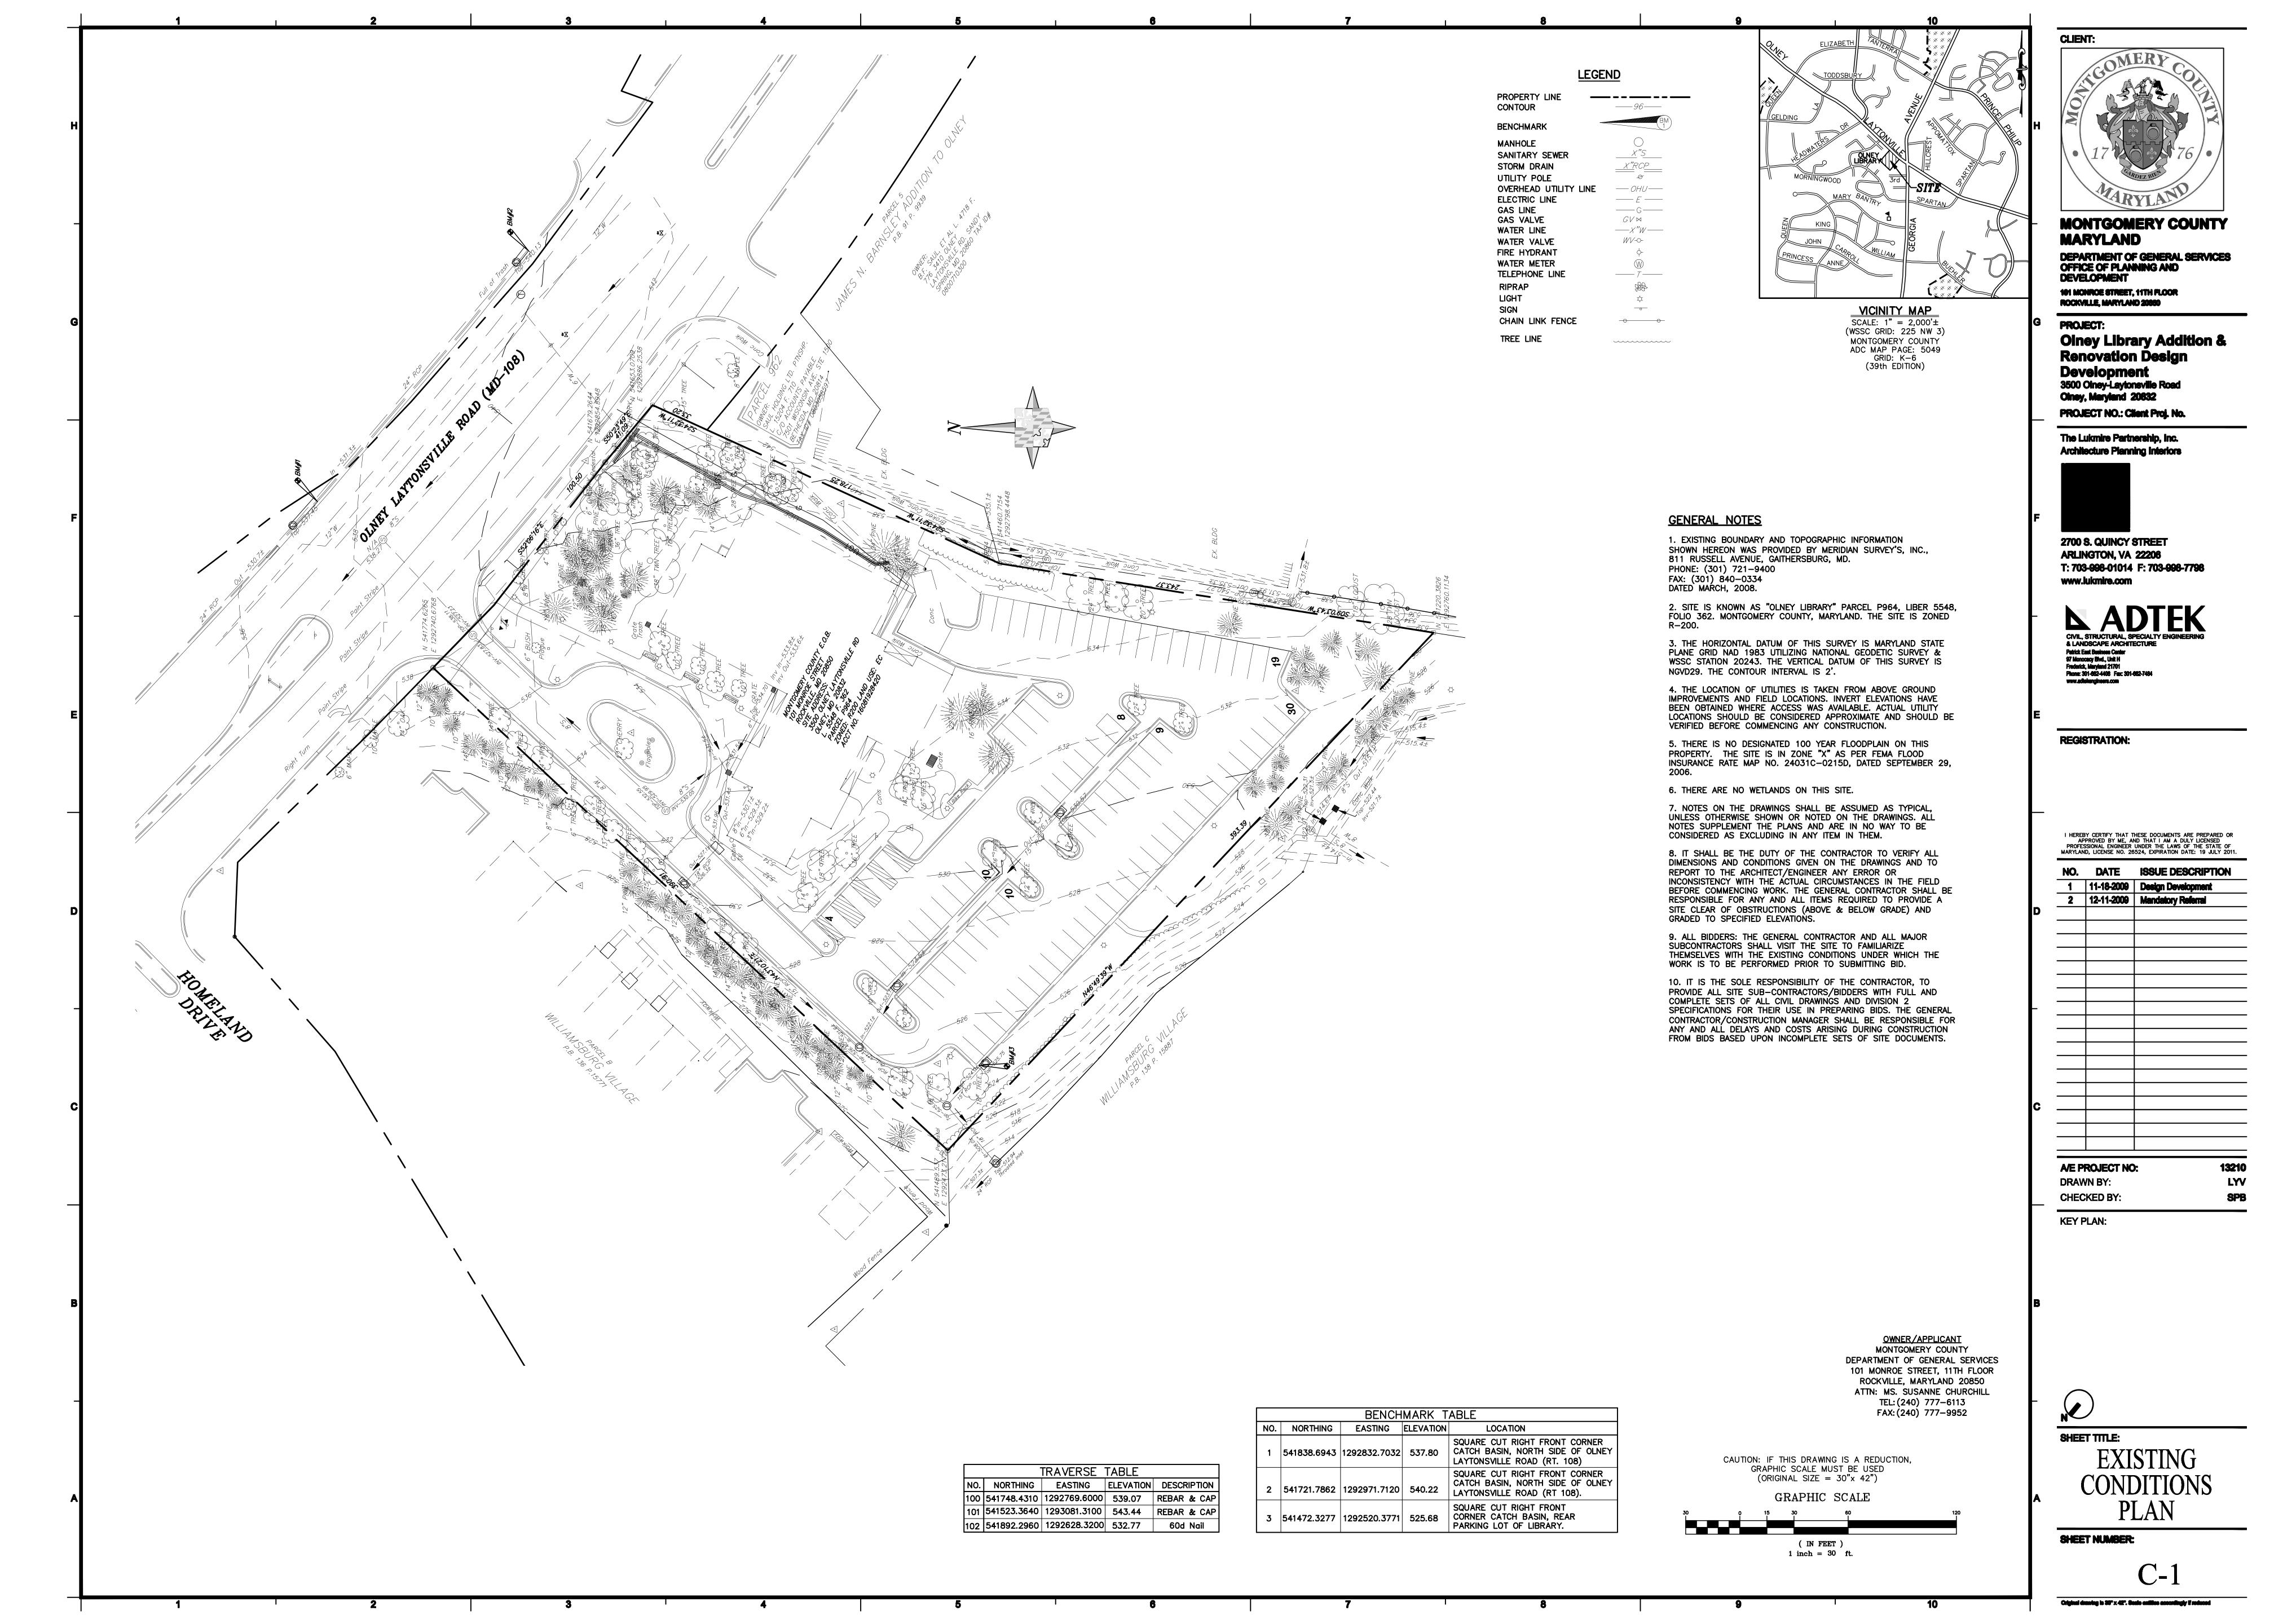

CLIENT:

## MONTGOMERY COUNTY MARYLAND DEPARTMENT OF GENERAL SERVICES

OFFICE OF PLANNING AND DEVELOPMENT

101 MONROE STREET, 11TH FLOOR ROCKVILLE, MARYLAND 20850

PROJECT:

Olney Library Addition & Renovation Design

**Development** 3500 Olney-Laytonsville Road Olney, Maryland 20832

PROJECT NO.: Client Proj. No.

The Lukmire Partnership, Inc.

Architecture Planning Interiors

The

2700 S. QUINCY STREET
ARLINGTON, VA 22206
T: 703-998-01014 F: 703-998-7798

www.lukmire.com

**N** ADTEK

& LANDSCAPE ARCHITECTURE
Patrick East Business Center
97 Monocacy Blvd., Unit H
Frederick, Maryland 21701
Phone: 301-662-4408 Fax: 301-662-7484
www.adtekengineers.com

REGISTRATION:

NO.	DATE	ISSUE DESCRIPTION
1	12-11-2009	Mandatory Referral
A/E P	ROJECT NO	): 1321
DRAW	/N BY:	LY

COMBINED

NRI/FSD &

TREE SAVE PLAN




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**KEY PLAN:** 

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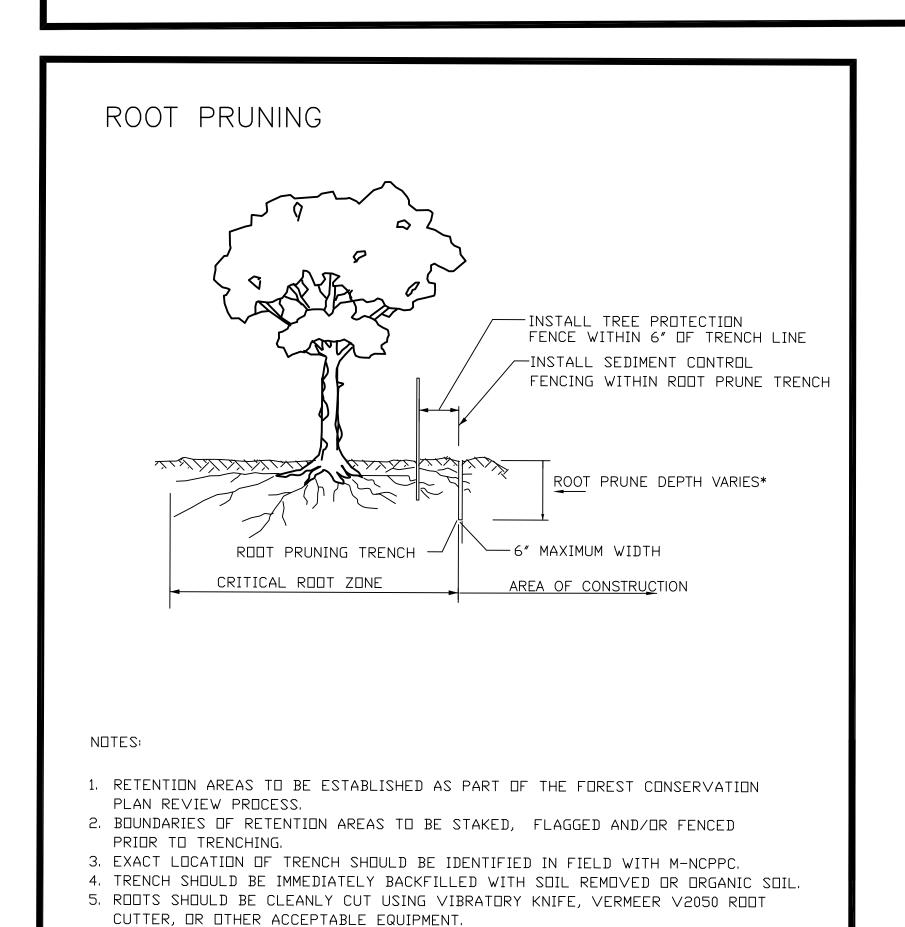


1. LOCATION AND LIMITS OF FENCING SHALL COORDINATED IN FIELD WITH ARBORIST

- BOUNDARIES OF PROTECTION AREA SHOULD BE STAKED
- PRIOR TO INSALLING PROTECTIVE DEVICE. ROOT DAMAGE SHOULD BE AVOIDED
- 4. PROTECTIVE SIGNAGE IS REQUIRED.
- <sup>5.</sup> FENCING SHALL BE MAINTAINED THROUGHOUT CONSTRUCTION.
- 6. TREE PROTECTION FENCE SHALL NOT BE REMOVED WITHOUT PRIOR CONSENT OF MNCPPC INSPECTOR.


### TREE PROTECTION FENCE DETAIL

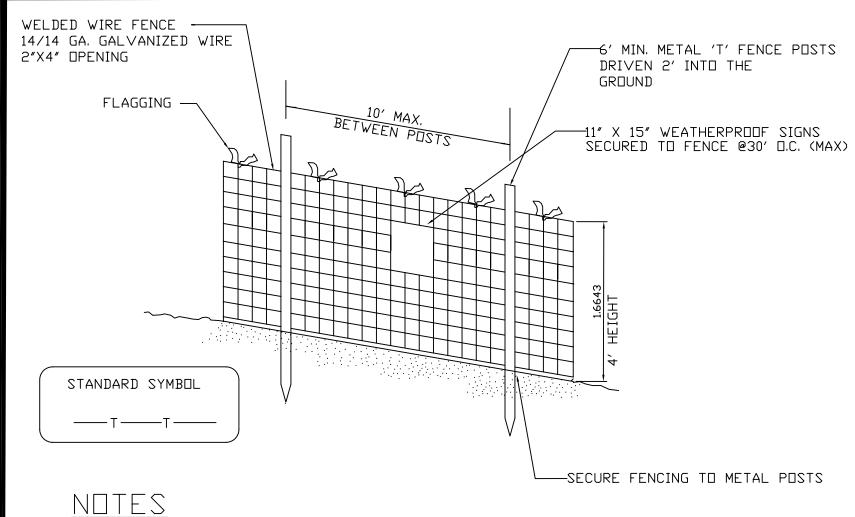NOT TO SCALE



\* ROOT PRUNE TO A DEPTH ONLY REQUIRED FOR SUPER SILT FENCE OR AS

DETERMINED AT THE PRECONSTRUCTION MEETING.

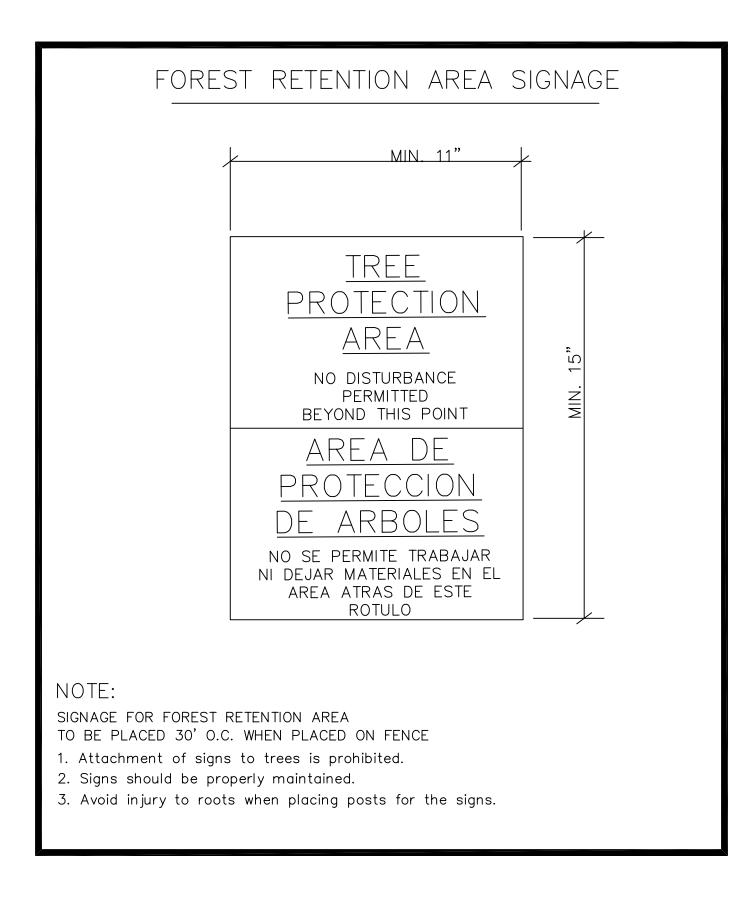

Site Inspections, Sequence of Construction for Tree Save Plan

#### **Inspections**

There shall be three inspections for the Tree Save Plan.


A. The Planning Department must conduct field inspections of a site subject to an approved tree save plan as follows:

- 1. After the limits of disturbance have been staked and flagged, but before any clearing or grading begins (the purpose of the meeting should be to field verify the limits of clearing specified on the approved plan, authorize necessary adjustments, and to authorize necessary stress reduction measures and installation of protection devices);
- 2. After necessary stress reduction measures have been completed and the protection measures have been installed, but before any clearing or grading begins (the purpose of the meeting should be to field verify that both measures have been done correctly and to authorize clearing and grading);
- 3. After completion of all construction activities to determine the level of compliance with the provisions of the tree save plan;
- B. These inspections must be requested by the Contractor at the designated points.

- 1. The attendants at the pre—construction meeting should include: owner, construction superintendent, MD licensed tree expert or ISA certified arborist, M—NCPPC inspection staff, sediment control inspector and Takoma Park Arborist.
- 2. Tree protection measures not specified on the tree save plan may be required as determined by M—NCPPC inspector in coordination with the MD licensed tree expert or ISA certified arborist and Takoma Park Arborist.

#### M-NCPPC STANDARD NOTES FOR EXEMPTION

- 1. Please include the following notes on tile Exemption plan:
- a. An on-site pre-construction meeting shall be required after the limits of disturbance have been staked and f1agcd, but before any clearing or grading begins The owner shall contact the Maryland National Capital Park and Planning Commission inspection staff prior to commencing construction to verify the limits of disturbance and discuss tree protection and tree protection measures. The attendants at this meeting should include developer's representative construction superintendent ISA certified arborist or MD licensed tree expert that will implement the tree protection measures, M-NCPPC inspector, and DPS sediment control inspector
- b. No clearing or grading shall begin before stress-reduction measures have been implemented. Appropriate measures may include, but are not limited
- Root pruning
- ii. Crown Reduction pruning
- iii. Watering iv. Fertilizing
- v. Vertical mulching
- vi. Root aeration matting
- Measures not specified on the Exemption plan be required as determined by the MNCPPC inspector in coordination with the arborist.
- c. A State of Maryland licensed tree expert, or an International Society of Arboriculture certified arborist must perform all stress reduction measures Documentation of stress reduction measures must be either observed by the MNCPFC inspector or sent to the MNCPPC inspector at 8787 Georgia Avenue, Silver Spring, MD 20910 The MNCPPC inspector will determine the exact method to convey the stress reductions measures the pre-construction
- d . Temporary tree protection devices shall be installed per the Exemption Plan and prior to any construction activities. Tree protection fencing locations should be staked prior to the pit-construction meeting MNCPPC inspector, in coordination with the DPS sediment control inspector, may make field adjustments to increase the survivability of trees and forest shown as saved on the approved plan temporary tree protect devices may include:
- i. Chain link fence: (four feet high) ii. Super silt fence with wire strung between the support poles (minimum 4
- feet high) with high visibility flagging iii. 14 gauge 2 inch x 4 inch welded wire fencing supported by steel T-bar
- posts (minimum 4 feet high) with high visibility flagging e. Temporary protection devices shall be maintained and installed by the contractor for the duration of construction project and must not be altered without prior approval from MNCPPC. No equipment, trucks, materials, or debris maybe stored within the tree protection fence areas during the entire construction project. No vehicle or equipment access to the fenced area wall be permitted Tree protection shall not be removed without prior approval of MNCPPC. Tree protection devices to be coordinated with erosion and sediment control devices as indicated on the approved Erosion and Sediment
- Control plan approved by the Department of Permitting Services. f. Forest retention area signs shall be installed as required by the MNCPPC inspector, or as shown approved plan.
- g. Periodic inspections by MNCPPC will occur during the construction project. Corrections and repairs to all tree protection devices, as determined by the MNCPPC inspector, must be made within the timeframe established by the MNCPPC inspector.
- h. After construction is complete, an inspection shall be requested.
- Corrective measures which may be required include: Removal and replacement of dead and dying trees
- ii. Pruning of dead or declining limbs iii. Soil erosion
- iv. Fertilization
- v. Watering
- vi. Wound repair
- vii. Clean up of retention areas
- After inspection and completion of corrective measures have been undertaken, all temporary protection devices shall be removed from the site. No additional grading, sodding, or burial may take place.

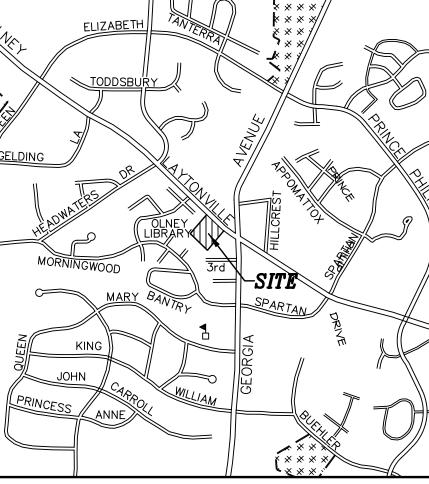

VICINITY MAP SCALE:  $1" = 2,000' \pm$ (WSSC GRID: 225 NW 3) MONTGOMERY COUNTY ADC MAP PAGE: 5049 GRID: K-6 (39th EDITION)

OWNER/APPLICANT MONTGOMERY COUNTY DEPARTMENT OF GENERAL SERVICES 101 MONROE STREET, 11TH FLOOR ROCKVILLE, MARYLAND 20850 ATTN: MS. SUSANNE CHURCHILL TEL: (240) 777-6113 FAX: (240) 777-9952

OWNER / PERMIT APPLICANT

MONTGOMERY COUNTY DPWT

C/O SHRI GONDOHALEKAR

101 MONROE STREET, 11TH FLOOR

ROCKVILLE MD, 20850

PHONE: (24<del>0</del>) 777-6071

FAX: (240) 777-6003

CERTIFICATION OF QUALIFIED PROFESSIONAL

ACCORDANCE WITH STATE OF MARYLAND, M-NCPPC AND MONTGOMERY COUNTY FOREST CONSERVATION LAWS.

MDNR / COMAR 08.19.06.01 QUALIFIED PROFESSIONAL

NORTON LAND DESIGN LLC

₹811 RUSSELL AVENUE, SUITE 301

E SHOWN DATE DUNE, 2009 PROJ. NO. 07-013

**p**.301.216.9650 f.301.216.9649 www.NORTONLANDDESIGN.com

I HEREBY CERTIFY THAT THE PLAN SHOWN HEREON HAS BEEN PREPARED IN ACCORDANCE


ISA CERTIFIED ARBORIST #177310

GAITHERSBURG, MD 20879

WATER CLASS III/III-P WATERSHED

MICHAEL A. NORTON

MD RLA #3310

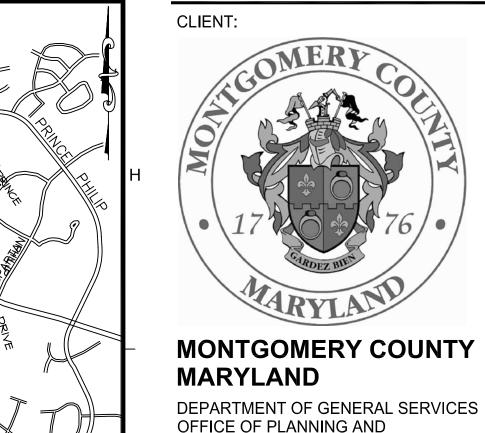

**Renovation Design** Development 3500 Olney-Laytonsville Road Olney, Maryland 20832

101 MONROE STREET, 11TH FLOOR

**Olney Library Addition &** 

ROCKVILLE, MARYLAND 20850

DEVELOPMENT

PROJECT:

PROJECT NO.: Client Proj. No.

The Lukmire Partnership, Inc. Architecture Planning Interiors



2700 S. QUINCY STREET ARLINGTON, VA 22206 T: 703-998-01014 F: 703-998-7798 www.lukmire.com

& LANDSCAPE ARCHITECTURE Patrick East Business Center 97 Monocacy Blvd., Unit H Frederick, Maryland 21701 Phone: 301-662-4408 Fax: 301-662-7484 www.adtekengineers.com

REGISTRATION:

NO. DATE ISSUE DESCRIPTION 1 | 12-11-2009 | Mandatory Referral

A/E PROJECT NO: DRAWN BY:

KEY PLAN:

CHECKED BY:

13210

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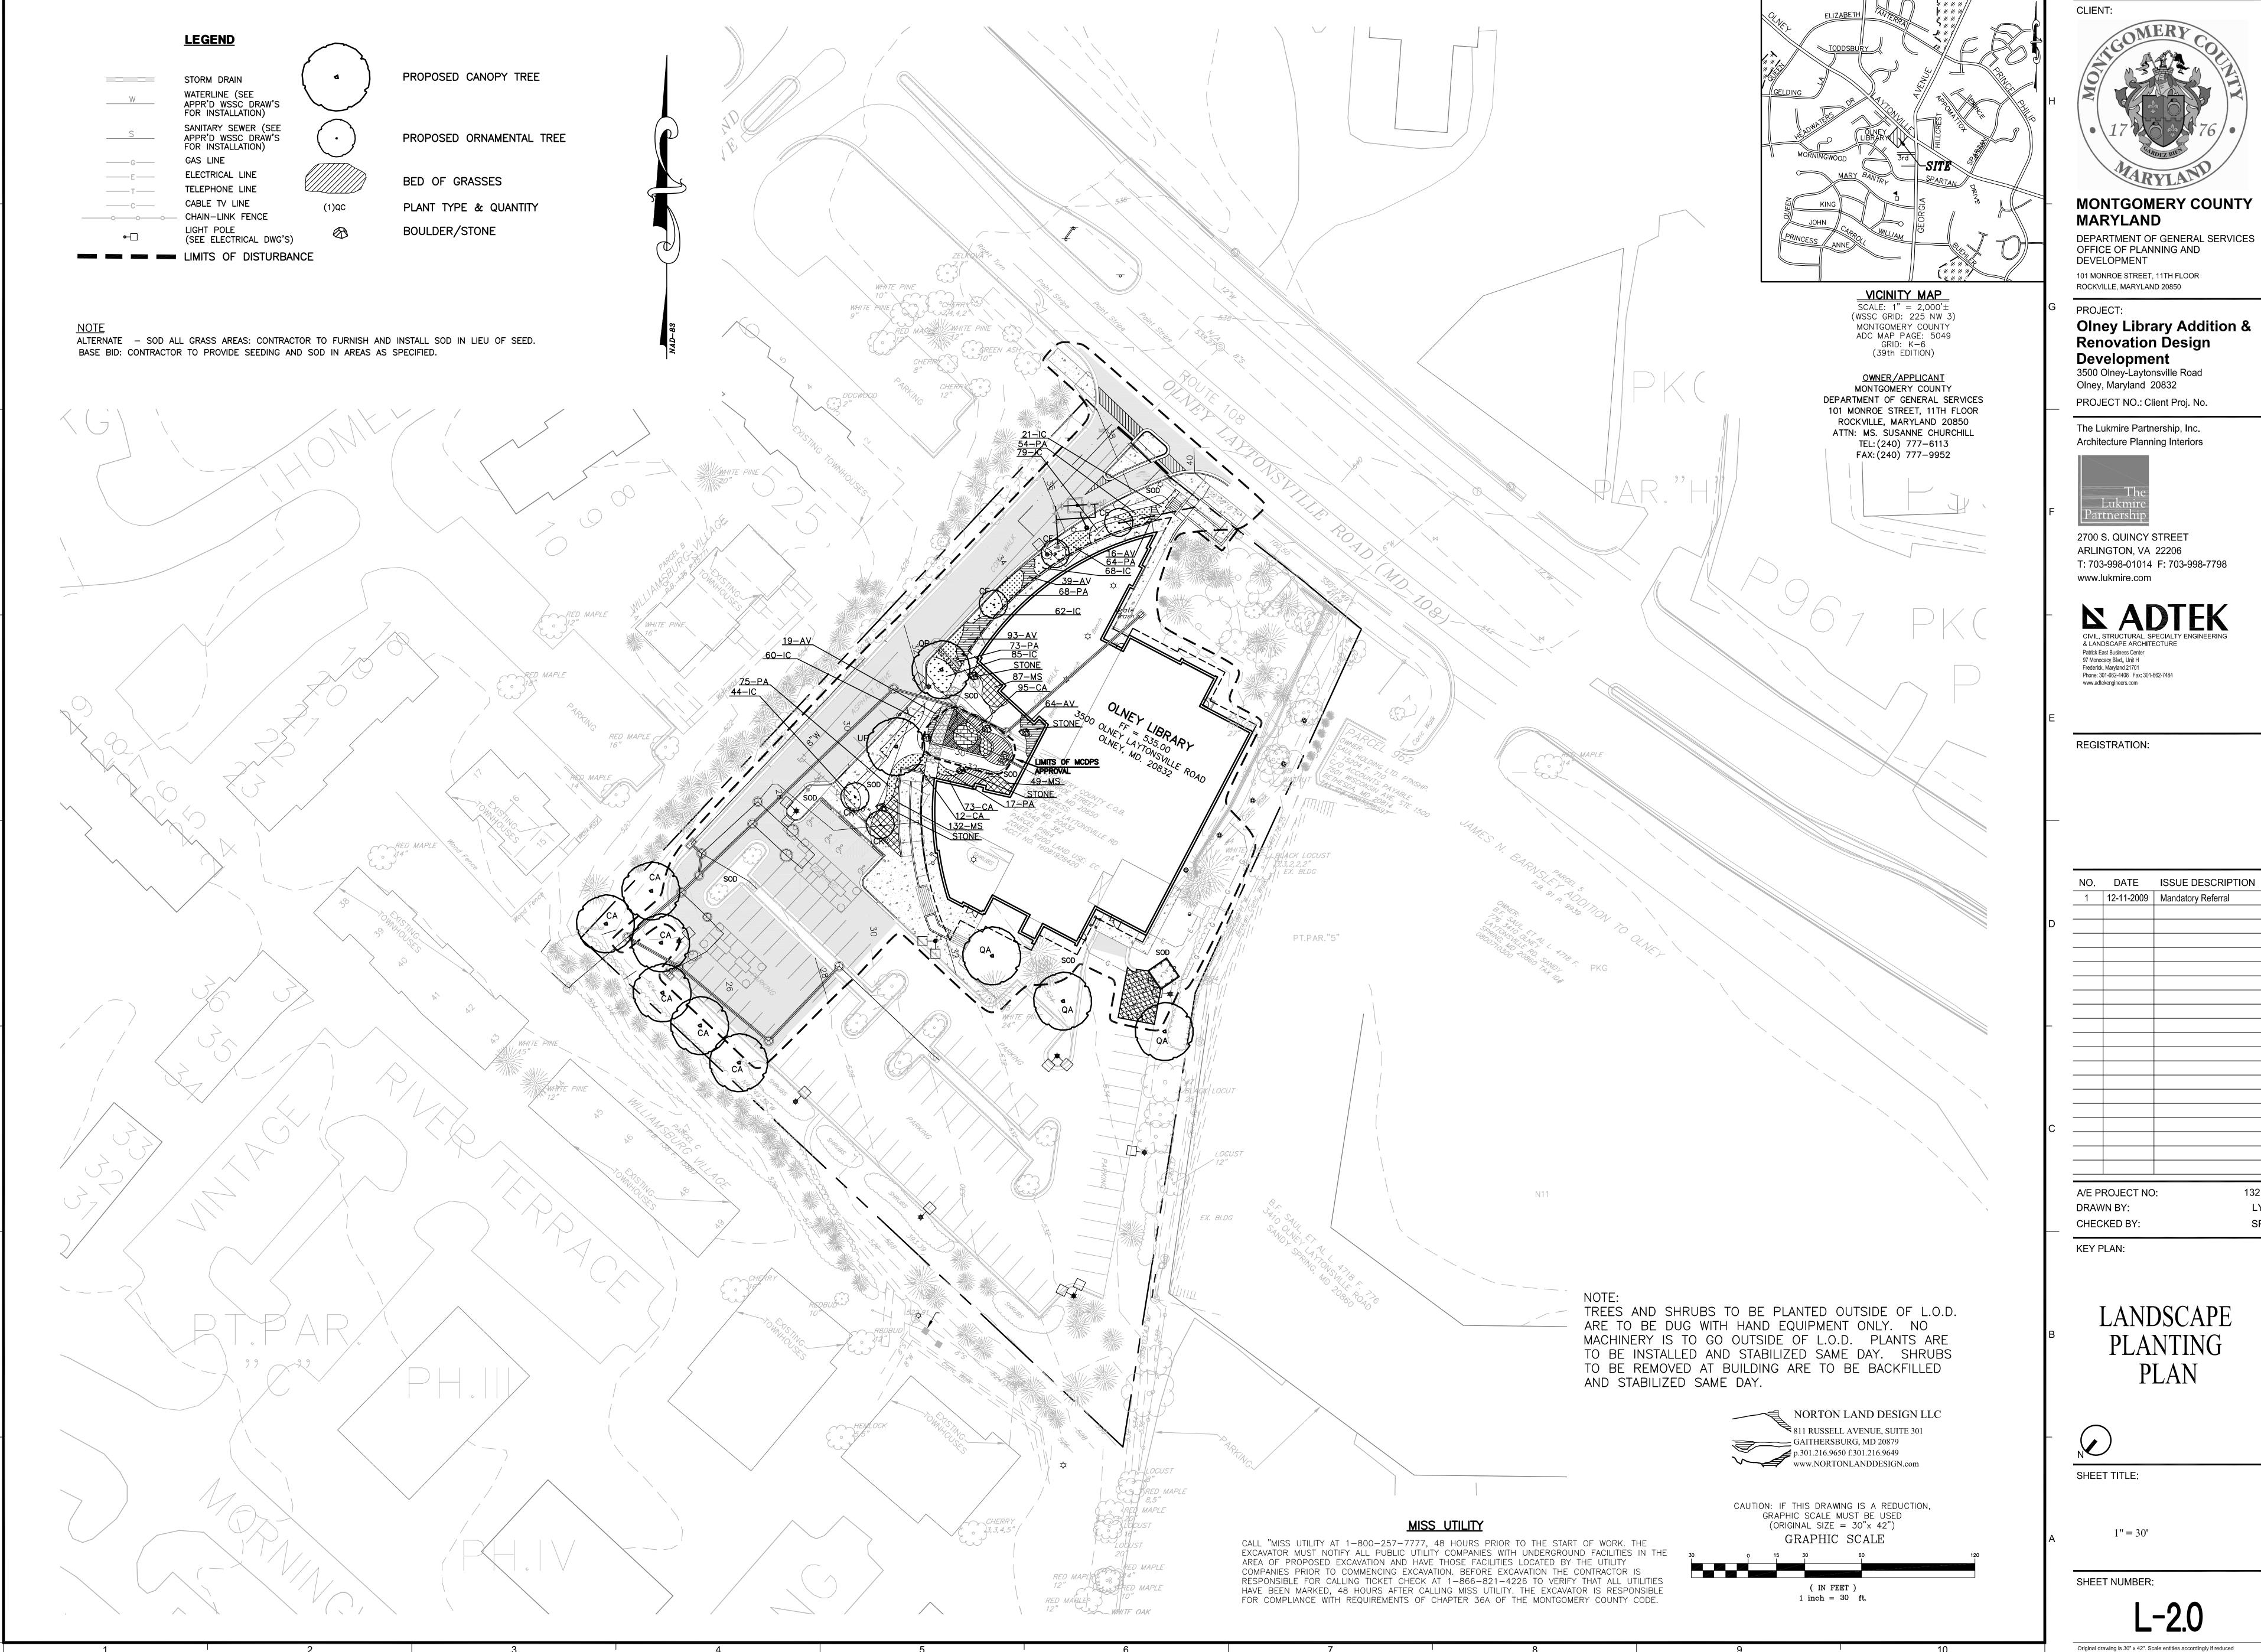
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Original drawing is 30" x 42". Scale entities accordingly if reduced

MISS UTILITY

EXCAVATOR MUST NOTIFY ALL PUBLIC UTILITY COMPANIES WITH UNDERGROUND FACILITIES IN THE AREA OF PROPOSED EXCAVATION AND HAVE THOSE FACILITIES LOCATED BY THE UTILITY COMPANIES PRIOR TO COMMENCING EXCAVATION. BEFORE EXCAVATION THE CONTRACTOR IS RESPONSIBLE FOR CALLING TICKET CHECK AT 1-866-821-4226 TO VERIFY THAT ALL UTILITIES HAVE BEEN MARKED, 48 HOURS AFTER CALLING MISS UTILITY. THE EXCAVATOR IS RESPONSIBLE FOR COMPLIANCE WITH REQUIREMENTS OF CHAPTER 36A OF THE MONTGOMERY COUNTY CODE.

CALL "MISS UTILITY AT 1-800-257-7777, 48 HOURS PRIOR TO THE START OF WORK. THE



PLANTING SPECIFICATIONS

SCOPE: Consists of supplying the planting trees, shrubs and herbaceous materials (groundcovers) including the staking of trees as specified herein and the supplying of materials, labor, equipment and work related services necessary for same as specified herein.

The work of this section includes, but is not limited to

fertilizing watering wrappina soil preparation staking plant materials planting replacement

MATERIALS: Wherever the following items appear in the specifications, they shall be as follows:

Topsoil The Contractor shall provide required natural, friable, fertile, fine sandy loam possessing the characteristics of representative topsoil in the vicinity which produce heavy growths of vegetation. The topsoil shall be free from subsoil, noxious weeds, stones, lime, cement, ashes, slag or other deleterious matter. Topsoil shall be well drained in its original condition and free of toxic quantities of acid or alkaline elements. It shall contain sand and clay in approximately equal proportions, and shall have an organic content by weight of not less than 2% nor more than 20% as determined by laboratory tests. The pH shall be between 6 and 7

Water Shall be furnished by the Contractor for the execution of all work specified in this contract. The Contractor shall verify that the water available is suitable for irrigation and free from ingredients harmful to

Peat Shall be only moss (sphagnum) peat; brown acid reaction approximately 4 to 5 pH; of standard commercial quality delivered to the site in bags or other convenient containers, in air dry condition. Peat shall be fully warranted by the producer.

Brace Stakes: Wood brace stakes shall be common lumber or the sizes in the following table: Tree Size Brace Stakes

1"-2.5" or < 8' tall 2.5"-3" or > 8' tall

2"x2"x24",2"x2"x30" for conifers

Wire shall be good commercial quality of galvanized wire. Wire used to stake trees shall be No. 12 gauge Hose Collars: Hose collars shall be new two ply fabric bearing garden hose not less than 2 inch inside

PLANT MATERIAL STANDARDS:

Association of Nurserymen, Inc., as published in the "American Standard for Nursery Stocks", latest edition. No substitutions of size or grade shall be permitted without written permission from the Landscape Designer. Each bundle of plants and all separate plants shall be properly identified with the legible waterproof tags securely fastened to each plant or bundle of plants. They shall remain on the plants until

Health All plants including their roots shall be free from disease, insects, or other injurious qualities. All local, state, and federal laws pertaining to the inspection, sale, and shipment of plant materials shall be complied with. The trunk bark of all trees shall be sound, trees shall have no large wounds, and any small wounds shall have a satisfactory callus roll formed or forming over them. Plants shall show good annual growth. Buds shall be plump and well filled for the species. Evergreen foliage shall be of good intense

Quality: All plants shall be true to type; they shall have normal, well-developed branch systems, and a vigorous fibrous root system; they shall be sound, healthy, vigorous plants free from defects, disfiguring knots, sunscald injuries, abrasions of the bark, plant diseases, insect eggs, borers, and all forms of infestation. All new plants shall be nursery grown.

Ball and Burlap: All balled and burlapped plants shall conform to the "American Standard for Nursery Stock", latest edition. All balls shall be of natural earth in which the plant has been growing. No manufactured or artificially produced or mudded-balls shall be accepted. Balls shall be firm and unbroken. and of large enough size to adequately enclose the plant's fibrous root system.

Plant List: The list of plants furnished with the specifications is for the information of the Contractor. The height and caliper of trees, the height or spread of shrubs, the diameter of the balls of roots are the minimum dimensions required. Plants indicated "B&B" are to be dug with a ball of earth and wrapped in

Measurements: Shall conform to those specified on the plant list except as follows: Oversize plants may be used only after approval by the designer.

Use of such plants shall not increase the contract price.

Height and spread dimensions indicated refer to the main body of the plant and not from branch tip to branch tip. All trees and shrubs shall be measured when their branches are in normal position. Trees shall have straight trunks with the leader intact, undamaged and uncut.

Inspection The Planting Contractor shall be responsible for all inspection and approval of the plant material that may be required by state, federal and other authorities, and he shall secure any permits and certificates that may be required.

All plants shall be subject to inspection, and approval at place of growth before digging, or upon delivery, for quality, size and variety; such approval shall not impair the right of rejection at the project site during progress of the work, for size, condition of balls, roots, latent defects or injuries. Rejected plants shall be removed immediately from the project site

DIGGING AND HANDLING

Protection from extremes in exposure and rough handling shall be provided all plant materials during

All plant materials shall be assembled in one location on the job site to permit inspection and approval by the designer. The Contractor shall notify the designer five (5) working days prior to planting so that a mutually agreeable time may be arranged for inspection. Stock with broken root balls or loose containers, and stock which shows evidence of being root-bound, over-grown, or recently canned, or in the opinion of the designer is damaged or improperly cared for, shall be removed from the site immediately and replaced at the Contractor's expense with another plant meeting the original specifications.

PROCEDURE Tree Planting

Layout All trees shall be located as designated in the field by the planting plan. Where below ground or overhead obstructions are encountered, the trees shall be relocated by the designer.

Planting Pits: Shall be a diameter two (2) times the diameter of the ball of the tree or container diameter The depth of the pit shall be enough to accommodate the ball or roots of the tree when the tree is set to finish grade. Prior to 3" of existing soil shall be mixed with the topsoil at a 1:1 ratio to reduce puddling beneath plantings. Planting islands within the parking lot shall be brought to

Planting Soil Preparation: Mix then one part peat moss with five parts topsoil. Mix all components thoroughly before backfilling.

Plants shall not be pruned prior to approval by the designer.

Setting of Trees: Before setting the trees, pits shall be watered. All plants shall be placed at such a level that, after settlement the natural relationship between the original grade at which the plant grew, the ball shall be 1/8 higher than the finish grading. Trees shall be planted plumb, oriented for desired effect as directed by the designer. Topsoil shall be tamped under and around the base of each ball to fill all voids and shall be placed in 6 to 8 inch layers, each thoroughly tamped and puddled. Burlap shall be removed from the sides and top of balls and from under the balls. When planting bare root trees, care shall be taken to work topsoil in around the roots and to spread them in a natural position before backfilling. Shallow basin or saucers a little larger than the diameter of the ball shall be formed around all trees to hold additional water.

Mulch Shall be applied to all tree pits to a depth of 3".

Pruning: All trees shall be neatly pruned after planting in accordance with the best standard practices and as directed by the designer. The tree shall be pruned to preserve its natural form and character and in a manner appropriate to its particular requirements. In general, at least one third of the deciduous trees shall be removed by thinning or shortening of branches but no leaders shall be cut. All pruning shall be done with clean, sharp tools.

Shrub and Herbaceous Materials: (groundcover)

final grade with 6" of planting soil.

Layout Herbaceous planting beds and shrub pit locations shall be designated by the designer in accordance with the plant list and the tentative locations shown on the planting plan. The general

form of the planting bed shall be staked out and excavations performed within the stakes.

Preparation of Herbaceous Planting Beds The ground shall be thoroughly broken to a depth of 12 inches The top 4 inches shall be worked by the contractor until the soil is completely fined and in a mellow condition to finish grade. All organic material shall either be worked into the soil or removed from the site. Clumps shall be removed from the site. All shall be performed perpendicular to the direction of surface drainage. All holes, depressions and rivulets shall be filled and brought to a smooth grade

Shrub Planting Pits: Shall not have vertical sides. The diameter of the pits shall be two times greater than the diameter of the ball or containerof the shrub. The depth of the pit shall be enough to accommodate the ball or roots of the shrub when the shrub is set to finish grade. 3" of existing soil shall be mixed with the topsoil at a 1:1 ratio to reduce puddling beneath plantings.

Shrub Planting Soil: Mix one part peat moss with five parts topsoil. Mix all components thoroughly before backfilling.

Setting of Shrubs: All materials shall be planted 2" higher in relation to the finish grade as they had before transplanting. The depth of the holes, as hereafter specified, shall be understood to be the depth below Balled and burlapped plants shall have topsoil tamped under the balls. All burlap, ropes, staves, etc., shall be taken off the tops of the balls and removed from the ball before backfilling. Roots of bare root plants shall not be left matted together, but shall be arranged in natural positions and shall have topsoil worked in among them. All broken and frayed roots shall be properly removed by trimming.

The Backfill of Topsoil: Shall be tamped in successive 8" layers. When the hole has been 2/3 backfilled, water shall be poured in filling the hole, and allowed to soak away so that all voids or air pockets under or around the roots are eliminated. After the water has soaked away, the hole shall be completely backfilled with "topsoil". After the backfill settles, additional soil shall be filled in, to the level of the finish grade. A shallow saucer of soil shall be formed around the edge of each hole to hold additional water.

#### MISS UTILITY

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FOR COMPLIANCE WITH REQUIREMENTS OF CHAPTER 36A OF THE MONTGOMERY COUNTY CODE.

Pruning: All shrubs shall be neatly pruned or thinned immediately after planting in accordance with best standard practices and as directed by the designer. Broken or bruised branches shall be removed with a clean cut. Each shrub shall be pruned to preserve its natural form or character and in a manner appropriate to its particular requirements. All pruning and thinning shall be done with sharp, clean tools.

Mulch: Shall be applied to all shrub beds and pits to a depth of 3" and to all herbaceous planting beds to a depth of 2" & evenly around the sides of the tree, outside of the ball. All stakes shall be oriented to a line parallel with the normal prevailing winds, or as directed by the designer. See planting details for staking locations.

TEMPORARY STORAGE AND HEELING-IN:

No heel—in plant material will be accepted, nor will any temporary heeling—in storage be permitted

Plant material unloaded and accepted by the inspector shall be immediately transported to the planting site and planted. Material left out of ground overnight or left with its roots bare to the sun, or otherwise unprotected during transit, unloading or storage shall be rejected by the designer, if in his judgment such lack of protection has caused damage to the roots of the plant or in any other way injured the plant material. MAINTENANCE:

The planting contractor shall be required to make periodic checks on the total project to make certain that the materials are properly cared for and that the sum of all conditions are contributing to the satisfactory progress of the materials, until such time as the work is approved by the designer. INSPECTION AND ACCEPTANCE:

Inspection of this work will be made by the designer at the conclusion of the planting period upon written notice by the Contractor at least five (5) days prior to anticipated date. Condition of all plant materials will be noted and recorded for reference.

After inspection, the planting contractor will be notified in writing by the designer if there are any deficiencies of the requirements for acceptance of the work. **GUARANTEE AND REPLACEMENT:** 

Trees and shrubs shall be guaranteed for a maximum of one full year of growing seasons after installation and shall be alive and in satisfactory condition at the end of the guarantee period. Such guarantee excludes vandalism.

DEFINITION FOR FURNISHED AND INSTALLING PLANT MATERIAL

The unit price contained in the bid proposal for furnished and installing plant and shrub material shall be defined to include furnishing and installing material, all planting soils (if applicable), staking and a guarantee for one year or growing season (excluding vandalism).

#### PUBLIC UTILITIES:

1. Care shall be exercised in excavation near utilities. If at any time Contractor damages the utilities in place through negligence or carelessness, Contractor shall pay for the full cost of repairing such damages. Contractor shall notify the appropriate person in the office of any utility whose lines may be affected.

2. The locations of utilities shown on the plans are approximates only and do not necessarily indicate all the utilities that may be encountered during construction The failure of a utility to be shown on the plans does not relieve Contractor of the responsibility for any injuries he may inflict on the utility, and in case of injury, it shall be repaired at the expense of the Contractor.

Whenever other utilities are encountered whose present grade would conflict with the new construction, Contractor shall notify Landscape Architect, who shall arrange revisions without unreasonable delay. Trenching or tunneling under existing utilities, culverts, etc., and providing temporary support shall be done at no additional expense to Owner.

GUARANTEE AND REPLACEMENT: The Contractor will guarantee survival of plants (each species) after one year. If at this time the total number of plants has fallen below this threshold, the Contractor will make a one—time replacement to bring plant numbers to the 100% levels for each species. Care shall be taken such that the activities involved in replacement planting do not cause damage or detrimental effect to the surviving flora. Any plants damaged by these activities will also be replaced by the Contractor to the 100% threshold.

Trees, shrubs and ground covers shall be guaranteed for 1 year after installation and shall be alive and in satisfactory condition at the end of the guarantee period Such guarantee excludes vandalism

DEFINITION FOR FURNISHED AND INSTALLING PLANT MATERIAL: The price contained in the bid proposal for furnished and installing plant and shrub material shall be defined to include furnishing and installing material, all planting soils (if applicable), staking and a guarantee for 12 months (excluding vandalism).

PROTECTION OF PRIVATE PROPERTY: Contractor shall repair or replace all fences, concrete walls, concrete curbs, gravel and asphalt driveways, signs, culverts, and all other miscellaneous improvements, at no additional expense to Ówner, damaged by Contractor due to his operations on the project, to a condition equal to or better than their condition before

#### JOB CONDITIONS:

1. Examine and evaluate grades, soils and water levels, observe the conditions under which work is to be performed, and notify the Landscape Architect of unsatisfactory conditions. Do not proceed with the work until unsatisfactory conditions have been corrected in an

Utilities: Review underground utilities location maps and plans provided by owner; demonstrate an awareness of utility locations, and certify acceptance of liability for the protection of utilities during course of work. Contractor shall be responsible for any damage to utilities or property.

Excavation: When conditions detrimental to plant growth are encountered, such as rubble fill, adverse drainage conditions, or obstructions, notify Landscape Architect

The Maryland-National Capital Park and Planning Commission



	KEY	BOTANICAL NAME	COMMON NAME	SIZE	FORM	SPACING	QUANTITY	COMMENTS	
0		TREES							OWNER/APPLICANT MONTGOMERY COUNTY DEPARTMENT OF GENERAL SERVICES
	CA	CARPINUS CAROLINIANA	AMERICAN HORNBEAM	2"CAL.	B&B	SHOWN	6		101 MONROE STREET, 11TH FLOOR ROCKVILLE, MARYLAND 20850 ATTN: MS. SUSANNE CHURCHILL
	CF	CORNUS FLORIDA "CHEROKEE PRINCESS"	CHEROKEE PRINCESS DOGWOOD	6'-8'	В&В	SHOWN	4	ORNAMENTAL	TEL: (240) 777-6113 TREE FAX: (240) 777-9952
	СК	CORNUS KOUSA	KOUSA DOGWOOD	4'-5'	B&B	SHOWN	2	ORNAMENTAL	TREE
	QA	QUERCUS ALBA	WHITE OAK	2" CAL	B&B	SHOWN	3		
	QP	QUERCUS PHELLOS	WILLOW OAK	2" CAL	B&B	SHOWN	1		
	UP	ULMUS PARVIFOLIA 'BOSQUE'	'BOSQUE' ELM	2" CAL.	В&В	SHOWN	1		
		GRASSES							
	AV	ANDROPOGON VIRGINICUS	BROOM SEDGE	2"	PLUG	18" O.C.	231		
	CA	CALAMAGROSTIS ACUTIFLORA 'KARL FORSTER'	KARL FORSTER FEATHER REED GRASS	2"	PLUG	18" O.C.	180		
	IC	IMPERATA CYLINDRICA 'RED BARON'	JAPANESE BLOOD GRASS	2"	PLUG	18" O.C.	420		
	MS	MISCANTHUS SINENSIS 'YAKU-JIMA'	DWARF MAIDEN GRASS	2"	PLUG	18" O.C.	268		
	PA	PENNISETUM ALOPECUROIDES 'HAMELIN'	DWARF FOUNTAIN GRASS	2"	PLUG	18" O.C.	412		


#### SOD & SEED MIX DESCRIPTIONS

SOD	SOD -TALL FESCUE/KENTUCKY BLUEGRASS	SQUARE YARD	ı	STABILIZATION AROUND SCHOOL
S-1	*LAWN- MD CERTIFIED TALL FESCUE (85%) SEED PERENNIAL RYEGRASS (10%) KENTUCKY BLUEGRASS (5%)	150LBS/ACRE	1	STABILIZATION
COMPANION SEED	ANNUAL RYEGRASS COMPANION CROP FOR MIXES AS REQUIRED	30LBS/ACRE	ı	STABILIZATION


ALTERNATE - SOD ALL GRASS AREAS: CONTRACTOR TO FURNISH AND INSTALL SOD IN LIEU OF SEED. BASE BID: CONTRACTOR TO PROVIDE SEEDING AND SOD IN AREAS AS SPECIFIED.

- \* FERTILIZER AT RATE BASED UPON SOIL SAMPLE RESULTS; LIME RATE BASED UPON SOIL SAMPLE RESULTS \*\* COVER WITH STRAW MULCH & LIME@ RATE OF 2 TONS/ACRE
- SITE STABILIZATION NOTE:
- ALL DISTURBED AREAS ARE TO BE STABILIZED WITH SHA SEED MIX NO. 1 FOR SLOPES LESS THAN 4:1 ALL DISTURBED AREAS ARE TO BE STABILIZED WITH MD CERTIFIED SOD FOR SLOPES EQUAL TO 4:1 TO SLOPES 3:1.
- ALL DISTUBED AREAS GREATER THAN 3:1 SHALL BE STABILIZED WITH SHA SEED MIX NO. 1, AT A RATE OF 125 LBS./ACRE

NOTE: FOR ALL DISTURBED AREAS NOT SHOWN OR COVERED ON THE LANDSCAPE PLAN, SEE PERMANENT SEEDING REQUIREMENTS ON EROSION & SEDIMENT CONTROL DRAWINGS.

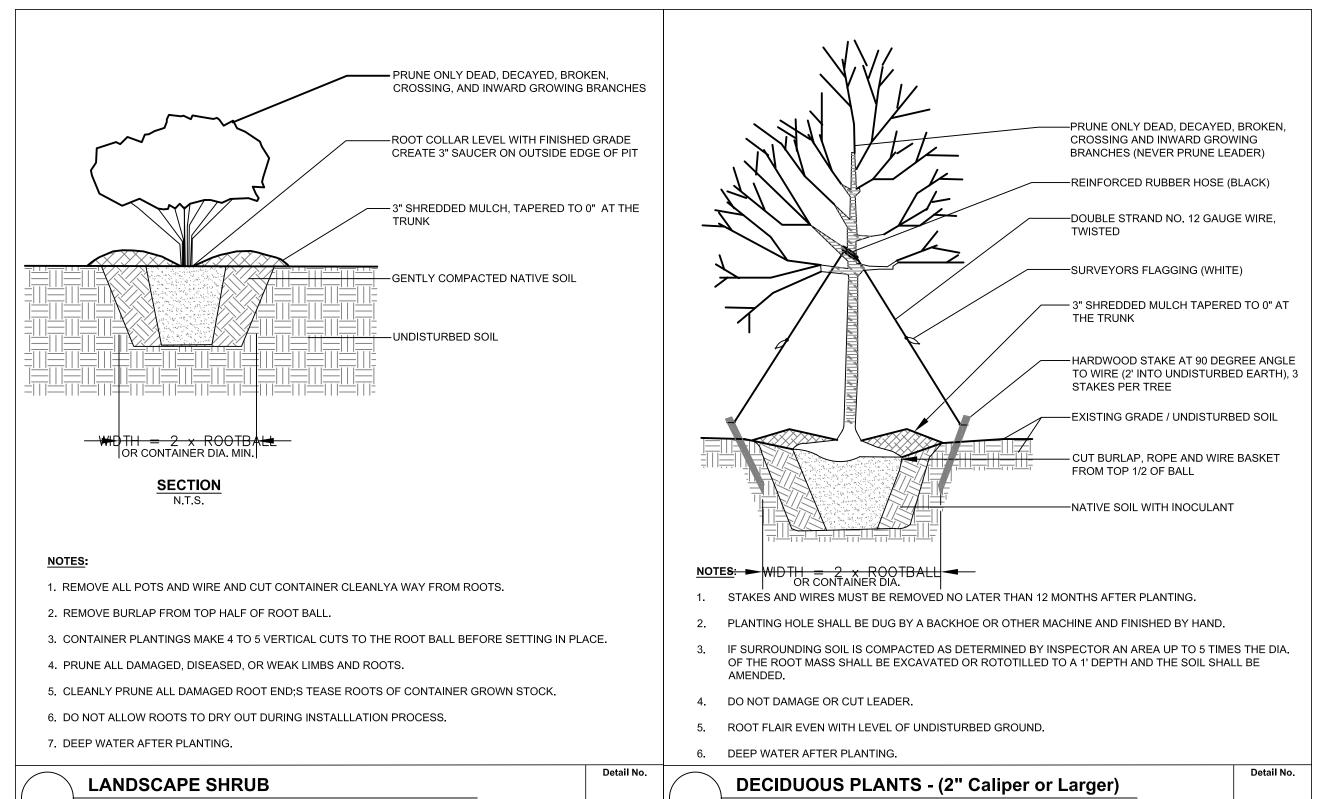


The Maryland-National Capital Park and Planning Commission

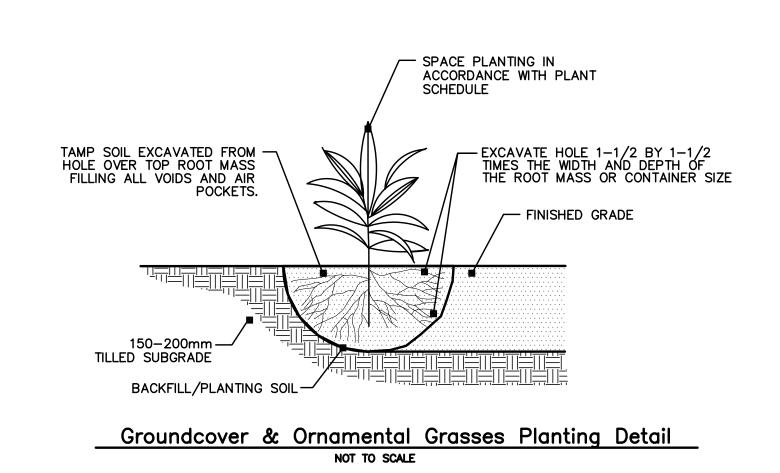

NORTON LAND DESIGN LLC § 811 RUSSELL AVENUE, SUITE 301 GAITHERSBURG, MD 20879 **∠** p.301.216.9650 f.301.216.9649

www.NORTONLANDDESIGN.com

(ORIGINAL SIZE = 30"x 42")

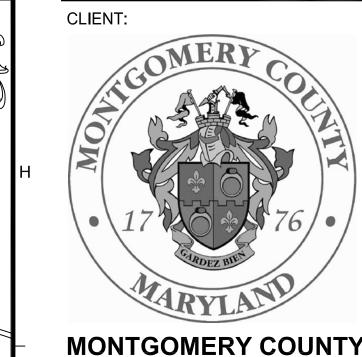

#### MARYLAND DEPARTMENT OF GENERAL SERVICES

OFFICE OF PLANNING AND DEVELOPMENT 101 MONROE STREET, 11TH FLOOR ROCKVILLE, MARYLAND 20850

PROJECT:

VICINITY MAP

 $\overline{\text{SCALE: 1"}} = 2,000' \pm$ 

(WSSC GRID: 225 NW 3)

MONTGOMERY COUNTY

ADC MAP PAGE: 5049

GRID: K-6

(39th EDITION)

#### Olney Library Addition & **Renovation Design**

Development 3500 Olney-Laytonsville Road Olney, Maryland 20832

PROJECT NO.: Client Proj. No.

The Lukmire Partnership, Inc. Architecture Planning Interiors



2700 S. QUINCY STREET ARLINGTON, VA 22206 T: 703-998-01014 F: 703-998-7798 www.lukmire.com

### & LANDSCAPE ARCHITECTURE

Patrick East Business Center 97 Monocacy Blvd., Unit H Frederick, Maryland 21701 Phone: 301-662-4408 Fax: 301-662-7484 www.adtekengineers.com

REGISTRATION:

NO. DATE ISSUE DESCRIPTION 1 | 12-11-2009 | Mandatory Referral

13210 A/E PROJECT NO: LYV DRAWN BY: CHECKED BY: SPB



**KEY PLAN:** 

SHEET TITLE:

SHEET NUMBER:

PLANTING SPECIFICATIONS SCOPE: Consists of supplying the planting trees, shrubs and herbaceous materials (groundcovers) including the staking of trees as specified herein and the supplying of materials, labor, equipment and work related services necessary for same as specified herein.

The work of this section includes, but is not limited to: fertilizing watering wrapping soil preparation stakina plant materials maintenance replacement

MATERIALS: Wherever the following items appear in the specifications, they shall be as follows: Topsoil The Contractor shall provide required natural, friable, fertile, fine sandy loam possessing the characteristics of representative topsoil in the vicinity which produce heavy growths of vegetation. The topsoil shall be free from subsoil, noxious weeds, stones, lime, cement, ashes, slag or other deleterious matter. Topsoil shall be well drained in its original condition and free of toxic quantities of acid or alkaline elements. It shall contain sand and clay in approximately equal proportions, and shall have an organic

Water Shall be furnished by the Contractor for the execution of all work specified in this contract. The Contractor shall verify that the water available is suitable for irrigation and free from ingredients harmful to

content by weight of not less than 2% nor more than 20% as determined by laboratory tests. The pH shall

Peat Shall be only moss (sphagnum) peat; brown acid reaction approximately 4 to 5 pH; of standard commercial quality delivered to the site in bags or other convenient containers, in air dry condition. Peat shall be fully warranted by the producer.

Brace Stakes: Wood brace stakes shall be common lumber or the sizes in the following table:

be between 6 and 7.

1"-2.5" or< 8' tall 2"x2"x24",2"x2"x30" for conifers 2.5"-3" or > 8' tall

Wire shall be good commercial quality of galvanized wire. Wire used to stake trees shall be No. 12 gauge

Hose Collars: Hose collars shall be new two ply fabric bearing garden hose not less than 2 inch inside diameter. PLANT MATERIAL STANDARDS

Association of Nurserymen, Inc., as published in the "American Standard for Nursery Stocks", latest edition. No substitutions of size or grade shall be permitted without written permission from the Landscape Designer. Each bundle of plants and all separate plants shall be properly identified with the legible waterproof tags securely fastened to each plant or bundle of plants. They shall remain on the plants until

Health All plants including their roots shall be free from disease, insects, or other injurious qualities. All local, state, and federal laws pertaining to the inspection, sale, and shipment of plant materials shall be complied with. The trunk bark of all trees shall be sound, trees shall have no large wounds, and any small wounds shall have a satisfactory callus roll formed or forming over them. Plants shall show good annual growth. Buds shall be plump and well filled for the species. Evergreen foliage shall be of good intense

Quality: All plants shall be true to type; they shall have normal, well—developed branch systems, and a vigorous fibrous root system; they shall be sound, healthy, vigorous plants free from defects, disfiguring knots, sunscald injuries, abrasions of the bark, plant diseases, insect eggs, borers, and all forms of infestation. All new plants shall be nursery grown.

Ball and Burlap: All balled and burlapped plants shall conform to the "American Standard for Nursery Stock". latest edition. All balls shall be of natural earth in which the plant has been growing. No manufactured or artificially produced or mudded-balls shall be accepted. Balls shall be firm and unbroken, and of large enough size to adequately enclose the plant's fibrous root system.

Plant List: The list of plants furnished with the specifications is for the information of the Contractor. The height and caliper of trees, the height or spread of shrubs, the diameter of the balls of roots are the minimum dimensions required. Plants indicated "B&B" are to be dug with a ball of earth and wrapped in

Measurements: Shall conform to those specified on the plant list except as follows: Oversize plants may be used only after approval by the designer

Use of such plants shall not increase the contract price.

Height and spread dimensions indicated refer to the main body of the plant and not from branch tip to branch tip. All trees and shrubs shall be measured when their branches are in normal position. Trees shall have straight trunks with the leader intact, undamaged and uncut.

material that may be required by state, federal and other authorities, and he shall secure any permits and All plants shall be subject to inspection, and approval at place of growth before digging, or upon delivery, for quality, size and variety; such approval shall not impair the right of rejection at the

Inspection The Planting Contractor shall be responsible for all inspection and approval of the plant

project site during progress of the work, for size, condition of balls, roots, latent defects or injuries. Rejected plants shall be removed immediately from the project site DIGGING AND HANDLING

Protection from extremes in exposure and rough handling shall be provided all plant materials during

All plant materials shall be assembled in one location on the job site to permit inspection and approval by the designer. The Contractor shall notify the designer five (5) working days prior to planting so that a mutually agreeable time may be arranged for inspection. Stock with broken root balls or loose containers. and stock which shows evidence of being root-bound, over-grown, or recently canned, or in the opinion of the designer is damaged or improperly cared for, shall be removed from the site immediately and replaced at the Contractor's expense with another plant meeting the original specifications. Plants shall not be pruned prior to approval by the designer.

PROCEDURE :

Layout All trees shall be located as designated in the field by the planting plan. Where below ground or overhead obstructions are encountered, the trees shall be relocated by the designer.

Planting Pits: Shall be a diameter two (2) times the diameter of the ball of the tree or container diameter. The depth of the pit shall be enough to accommodate the ball or roots of the tree when the tree is set to finish grade. Prior to 3" of existing soil shall be mixed with the topsoil at a 1:1 ratio to reduce puddling beneath plantings. Planting islands within the parking lot shall be brought to final grade with 6" of planting soil.

Planting Soil Preparation: Mix then one part peat moss with five parts topsoil. Mix all components thoroughly before backfilling.

Before setting the trees, pits shall be watered. All plants shall be placed at such a level that, after settlement, the natural relationship between the original grade at which the plant grew, the ball shall be 1/8 higher than the finish grading. Trees shall be planted plumb, oriented for desired effect as directed by the designer. Topsoil shall be tamped under and around the base of each ball to fill all voids and shall be placed in 6 to 8 inch layers, each thoroughly tamped and puddled. Burlap shall be removed from the sides and top of balls and from under the balls. When planting bare root trees, care shall be taken to work topsoil in around the roots and to spread them in a natural position before backfilling. Shallow basin or saucers a little larger than the diameter of the ball shall be formed around all trees to hold additional water.

Mulch Shall be applied to all tree pits to a depth of 3".

Pruning: All trees shall be neatly pruned after planting in accordance with the best standard practices and as directed by the designer. The tree shall be pruned to preserve its natural form and character and in a manner appropriate to its particular requirements. In general, at least one third of the deciduous trees shall be removed by thinning or shortening of branches but no leaders shall be cut. All pruning shall be done with clean, sharp tools.

Shrub and Herbaceous Materials: (groundcover)

Layout Herbaceous planting beds and shrub pit locations shall be designated by the designer in accordance with the plant list and the tentative locations shown on the planting plan. The general form of the planting bed shall be staked out and excavations performed within the stakes.

Preparation of Herbaceous Planting Beds The ground shall be thoroughly broken to a depth of 12 inches. The top 4 inches shall be worked by the contractor until the soil is completely fined and in a mellow condition to finish grade. All organic material shall either be worked into the soil or removed from the site. Clumps shall be removed from the site. All shall be performed perpendicular to the direction of surface drainage. All holes, depressions and rivulets shall be filled and brought to a smooth grade.

Shrub Planting Pits: Shall not have vertical sides. The diameter of the pits shall be two times greater than the diameter of the ball or containerof the shrub. The depth of the pit shall be enough to accommodate the ball or roots of the shrub when the shrub is set to finish grade. 3" of existing soil shall be mixed with the topsoil at a 1:1 ratio to reduce puddling beneath plantings.

Shrub Planting Soil: Mix one part peat moss with five parts topsoil. Mix all components thoroughly before backfilling.

Setting of Shrubs: All materials shall be planted 2" higher in relation to the finish grade as they had before transplanting. The depth of the holes, as hereafter specified, shall be understood to be the depth below finish grade. Balled and burlapped plants shall have topsoil tamped under the balls. All burlap, ropes, staves, etc., shall be taken off the tops of the balls and removed from the ball before backfilling. Roots of bare root plants shall not be left matted together, but shall be arranged in natural positions and shall have topsoil worked in among them. All broken and frayed roots shall be properly removed by trimming. The Backfill of Topsoil: Shall be tamped in successive 8" layers. When the hole has been 2/3 backfilled, water shall be poured in filling the hole, and allowed to soak away so that all voids or air pockets under or around the roots are eliminated. After the water has soaked away, the hole shall be completely backfilled

with "topsoil". After the backfill settles, additional soil shall be filled in, to the level of the finish grade. A

#### MISS UTILITY

shallow saucer of soil shall be formed around the edge of each hole to hold additional water.

CALL "MISS UTILITY AT 1-800-257-7777, 48 HOURS PRIOR TO THE START OF WORK. THE EXCAVATOR MUST NOTIFY ALL PUBLIC UTILITY COMPANIES WITH UNDERGROUND FACILITIES IN THE AREA OF PROPOSED EXCAVATION AND HAVE THOSE FACILITIES LOCATED BY THE UTILITY COMPANIES PRIOR TO COMMENCING EXCAVATION. BEFORE EXCAVATION THE CONTRACTOR IS RESPONSIBLE FOR CALLING TICKET CHECK AT 1-866-821-4226 TO VERIFY THAT ALL UTILITIES HAVE BEEN MARKED, 48 HOURS AFTER CALLING MISS UTILITY. THE EXCAVATOR IS RESPONSIBLE FOR COMPLIANCE WITH REQUIREMENTS OF CHAPTER 36A OF THE MONTGOMERY COUNTY CODE.

Pruning: All shrubs shall be neatly pruned or thinned immediately after planting in accordance with best standard practices and as directed by the designer. Broken or bruised branches shall be removed with a clean cut. Each shrub shall be pruned to preserve its natural form or character and in a manner appropriate

to its particular requirements. All pruning and thinning shall be done with sharp, clean tools. Mulch: Shall be applied to all shrub beds and pits to a depth of 3" and to all herbaceous planting beds to a depth of 2" & evenly around the sides of the tree, outside of the ball. All stakes shall be oriented to a line parallel with the normal prevailing winds, or as directed by

TEMPORARY STORAGE AND HEELING-IN:

the designer. See planting details for staking locations.

No heel-in plant material will be accepted, nor will any temporary heeling-in storage be permitted

Plant material unloaded and accepted by the inspector shall be immediately transported to the planting site and planted. Material left out of ground overnight or left with its roots bare to the sun, or otherwise unprotected during transit, unloading or storage shall be rejected by the designer, if in his judgment such lack of protection has caused damage to the roots of the plant or in any other way injured the plant material. MAINTENANCE:

The planting contractor shall be required to make periodic checks on the total project to make certain that the materials are properly cared for and that the sum of all conditions are contributing to the satisfactory progress of the materials, until such time as the work is approved by the designer. INSPECTION AND ACCEPTANCE

Inspection of this work will be made by the designer at the conclusion of the planting period upon written notice by the Contractor at least five (5) days prior to anticipated date. Condition of all plant materials will be noted and

After inspection, the planting contractor will be notified in writing by the designer if there are any deficiencies of the requirements for acceptance of the work.

**GUARANTEE AND REPLACEMENT:** Trees and shrubs shall be guaranteed for a maximum of one full year or growing season after installation and shall be alive and in satisfactory condition at the end of the guarantee period. Such guarantee excludes vandalism.

DEFINITION FOR FURNISHED AND INSTALLING PLANT MATERIAL

The unit price contained in the bid proposal for furnished and installing plant and shrub material shall be defined to include furnishing and installing material, all planting soils (if applicable), staking and a guarantee for one year or growing season (excluding vandalism).

PUBLIC UTILITIES:

1. Care shall be exercised in excavation near utilities. If at any time Contractor damages the utilities in place through negligence or carelessness, Contractor shall pay for the full cost of repairing such damages. Contractor shall notify the appropriate person in the office of any utility whose lines may be affected. 2. The locations of utilities shown on the plans are approximates only and do not necessarily indicate all the utilities that may be encountered during construction. The failure of a utility to be shown on the plans does not relieve Contractor of the responsibility for any injuries he may inflict on the utility, and in case of injury, it

3. Whenever other utilities are encountered whose present grade would conflict with the new construction, Contractor shall notify Landscape Architect. who shall arrange revisions without unreasonable delay. Trenching or tunneling under existing utilities, culverts, etc., and providing temporary support shall be done at no additional expense to Owner.

shall be repaired at the expense of the Contractor.

GUARANTEE AND REPLACEMENT: The Contractor will guarantee survival of plants (each species) after one year. If at this time the total number of plants has fallen below this threshold, the Contractor will make a one—time replacement to bring plant numbers to the 100% levels for each species. Care shall be taken such that the activities involved in replacement planting do not cause damage or detrimental effect to the surviving flora. Any plants damaged by these activities will also be replaced by the Contractor to the 100% threshold.

Trees, shrubs and ground covers shall be guaranteed for 1 year after installation and shall be alive and in satisfactory condition at the end of the guarantee period. Such guarantee excludes vandalism.

DEFINITION FOR FURNISHED AND INSTALLING PLANT MATERIAL: The price contained in the bid proposal for furnished and installing plant and shrub material shall be defined to include furnishing and installing material, all planting soils (if applicable), staking and a guarantee for 12 months (excluding vandalism) PROTECTION OF PRIVATE PROPERTY: Contractor shall repair or replace all fences, concrete walls, concrete curbs, gravel and asphalt driveways, signs, culverts, and all other miscellaneous improvements, at no additional expense to Owner, damaged by Contractor due to his operations on the project, to a condition equal to or better than their condition before

JOB CONDITIONS:

1. Examine and evaluate grades, soils and water levels, observe the conditions under which work is to be performed, and notify the Landscape Architect of unsatisfactory conditions. Do not proceed with the work until unsatisfactory conditions have been corrected in an

2. Utilities: Review underground utilities location maps and plans provided by owner; demonstrate an awareness of utility locations, and certify acceptance of liability for the protection of utilities during course of work. Contractor shall be responsible for any

3. Excavation: When conditions detrimental to plant growth are encountered, such as rubble fill, adverse drainage conditions, or obstructions, notify Landscape Architect

S1 - LAWN SEED MIX

<del>- ₩DTH = 2 x ROOTBA</del>₩

2. REMOVE BURLAP FROM TOP HALF OF ROOT BALL.

LANDSCAPE SHRUB

7. DEEP WATER AFTER PLANTING.

4. PRUNE ALL DAMAGED, DISEASED, OR WEAK LIMBS AND ROOTS.

6. DO NOT ALLOW ROOTS TO DRY OUT DURING INSTALLLATION PROCESS.

The Maryland-National Capital Park and Planning Commission

1. REMOVE ALL POTS AND WIRE AND CUT CONTAINER CLEANLYA WAY FROM ROOTS.

3. CONTAINER PLANTINGS MAKE 4 TO 5 VERTICAL CUTS TO THE ROOT BALL BEFORE SETTING IN PLACE.

5. CLEANLY PRUNE ALL DAMAGED ROOT END;S TEASE ROOTS OF CONTAINER GROWN STOCK.

85% MD CERTIFIED TALL FESCUE 10% PERENNIAL RYEGRASS 5% KENTUCKY BLUEGRASS

damage to utilities or property.

<u> S2 — RETENTION BASIN FLOOR SEEDING — FOR WILDLIFE AND PLANT DIVERSITY</u> 25% ALOPECURUS ARUNDINACEUS VIRGINIA WILD RYE 25% ELYMUS VIRGINICUS 20% CAREX VULPINOIDEA FOX SEDGE TICKLEGRASS / ROUGH BENTGRASS AGROSTIS SCABRA 5% POA PALUSTRIS FOWL BLUEGRASS 4% BIDENS CERNUA NODDING BUR MRIGOLD SPARGANIUM EURYCARPUM GIANT BUR REED VERBENA HASTATA BLUE VERVAIN JUNCUS EFFUSUS SOFT RUSH SCIRPUS ATROVIRENS GREEN BULRUSH

SCIRPUS CYPERINUS WOOL GRASS 2% SCIRPUS POLYPHYLLUS MANY LEAVED BULRUSH 1% MIMULUS RINGENS SQUARE STEMMED MONKEY FLOWER ROUGH-LEAVED GOLDENROD 1% SOLIDAGO PATULA \* OVERSEED WITH ANNUAL RYEGRASS AS A COMPANION CROP AND EROSION CONTROL

- PRUNE ONLY DEAD, DECAYED, BROKEN,

CROSSING, AND INWARD GROWING BRANCHES

-ROOT COLLAR LEVEL WITH FINISHED GRADE

CREATE 3" SAUCER ON OUTSIDE EDGE OF PIT

- 3" SHREDDED MULCH, TAPERED TO 0" AT THE

GENTLY COMPACTED NATIVE SOIL

UNDISTURBED SOIL

STORM DRAIN WATERLINE (SEE APPR'D WSSC DRAW'S FOR INSTALLATION) SANITARY SEWER (SEE APPR'D WSSC DRAW'S FOR INSTALLATION) **ELECTRICAL LINE** TELEPHONE LINE CABLE TV LINE CHAIN-LINK FENCE

**LEGEND** 

(SEE ELECTRICAL DWG'S) BOULDER/STONE BED OF GRASSES

LIGHT POLE

1-QC

NOTES: → WIDTH = 2 × ROOTBALL OR CONTAINER DIA.

5. ROOT FLAIR EVEN WITH LEVEL OF UNDISTURBED GROUND.

4. DO NOT DAMAGE OR CUT LEADER.

DEEP WATER AFTER PLANTING.

1. STAKES AND WIRES MUST BE REMOVED NO LATER THAN 12 MONTHS AFTER PLANTING.

**DECIDUOUS PLANTS - (2" Caliper or Larger)** 

The Maryland-National Capital Park and Planning Commission

2. PLANTING HOLE SHALL BE DUG BY A BACKHOE OR OTHER MACHINE AND FINISHED BY HAND.

3. IF SURROUNDING SOIL IS COMPACTED AS DETERMINED BY INSPECTOR AN AREA UP TO 5 TIMES THE DIA. OF THE ROOT MASS SHALL BE EXCAVATED OR ROTOTILLED TO A 1' DEPTH AND THE SOIL SHALL BE

PLANT TYPE & QUANTITY LIMITS OF MCDPS LANDSCAPE **APPROVAL** 

S1-LAWN SEED MIX

S2-RETENTION SEED MIX

-PRUNE ONLY DEAD, DECAYED, BROKEN

CROSSING AND INWARD GROWING

BRANCHES (NEVER PRUNE LEADER)

—REINFORCED RUBBER HOSE (BLACK)

-DOUBLE STRAND NO. 12 GAUGE WIRE,

- 3" SHREDDED MULCH TAPERED TO 0" AT

HARDWOOD STAKE AT 90 DEGREE ANGLE

TO WIRE (2' INTO UNDISTURBED EARTH), 3

---EXISTING GRADE / UNDISTURBED SOIL

- CUT BURLAP, ROPE AND WIRE BASKET

-NATIVE SOIL WITH INOCULANT

—SURVEYORS FLAGGING (WHITE)

THE TRUNK

STAKES PER TREE



KEY	SWM FACILITY	BOTANICAL NAME	COMMON NAME		SIZE	FORM	SPACING	COMMENTS
NE I	QUANTITY	BOTANICAL NAME	COMMON NAME		SIZE	TORW	SFACING	COMMENTS
RASS	ES							
CS	70	CAREX STRICTA	TUSSOCK SED	)GE	2"	PLUG	18" O.C.	NATIVE
JE	33	JUNCUS EFFUSUS	SOFT RUSH		2"	PLUG	18" O.C.	NATIVE
PV	51	PANICUM VIRGATUM	SWITCH GRASS	S	2"	PLUG	18" O.C.	NATIVE
SEED	MIXES					•		
SOD	LIAT- GOS	FESCUE/KENTUCKY BLUFGRASS		SOD	SOD	SQUARE YARD		STABILIZATION DAM

SEED MIXES	SEED MIXES					
SOD	SOD -TALL FESCUE/KENTUCKY BLUEGRASS	SOD	SOD	SQUARE YARD	1	STABILIZATION DAM EMBANKMENT
S-1	*LAWN- MD CERTIFIED TALL FESCUE (85%) SEED PERENNIAL RYEGRASS (10%) KENTUCKY BLUEGRASS (5%)	SEED	SEED	150LBS/ACRE	1	STABILIZATION
S-2	*RETENTION SEED MIX	SEED	SEED	25LBS/ACRE	1	STABILIZATION
COMPANION SEED	ANNUAL RYEGRASS COMPANION CROP FOR MIXES AS REQUIRED	SEED	SEED	30LBS/ACRE	-	STABILIZATION

\* FERTILIZER PER SPECS AND SOIL SAMPLE RESULTS

SCALE: 1"=10'-0"

\*\* COVER WITH STRAW MULCH SITE STABILIZATION NOTE:

ALL DISTURBED AREAS ARE TO BE STABILIZED WITH LAWN SEED MIX FOR SLOPES LESS THAN 3:1 UNLESS NOTED ALL DISTURBED AREAS ARE TO BE STABILIZED WITH MD CERTIFIED SOD FOR SLOPES EQUAL TO 3:1 OR STEEPER.

NOTE: FOR ALL DISTURBED AREAS NOT SHOWN OR COVERED ON THE LANDSCAPE PLAN,

SEE PERM. SEEDING REQUIREMNTS ON EROSION & SEDIMENT CONTROL DRAWINGS

MCDPS SHEET NO.10 of 10

VICINITY MAP

SCALE:  $1'' = 2,000' \pm$ 

(WSSC GRID: 225 NW 3)

MONTGOMERY COUNTY

ADC MAP PAGE: 5049

GRID: K-6 (39th EDITION)

OWNER/APPLICANT

MONTGOMERY COUNTY

DEPARTMENT OF GENERAL SERVICES

101 MONROE STREET, 11TH FLOOR

ROCKVILLE, MARYLAND 20850

ATTN: MS. SUSANNE CHURCHILL

TEL: (240) 777-6113

FAX: (240) 777-9952

MCDPS APPROVED FOR:	
STORMWATER MANAGEMENT:	
REVIEWED	
APPROVED	
S.M. FILE #	
SEDIMENT CONTROL TECHNIC REQUIREMENTS:	AL
REVIEWED	DATE
APPROVED	DATE
ADMINISTRATIVE REQUIREMENT	S:
REVIEWED	DATE
SEDIMENT CONTROL PERMIT NO.	

SPACE PLANTING IN ACCORDANCE WITH PLANT SCHEDULE - EXCAVATE HOLE 1-1/2 BY 1-1/2 TIMES THE WIDTH AND DEPTH OF THE ROOT MASS OR CONTAINER SIZE HOLE OVER TOP ROOT MASS FILLING ALL VOIDS AND AIR - FINISHED GRADE 150-200mm-TILLED SUBGRADE BACKFILL/PLANTING SOIL— Groundcover & Ornamental Grasses Planting Detail

NORTON LAND DESIGN LLC 811 RUSSELL AVENUE, SUITE 301 GAITHERSBURG, MD 20879 **p**.301.216.9650 f.301.216.9649 www.NORTONLANDDESIGN.com

(ORIGINAL SIZE =  $30" \times 42"$ )

CDPS APPROVAL OF THIS PLAN WILL <u>EXPIRE</u> ONE YEAR FROM THE DATE OF APPROVAL IF THE PROJECT HAS NOT STARTED UNLESS THE PERMIT HAS BEEN EXTENDED.

OTE: MCDPS APPROVAL DOES NOT NEGATE

THE NEED OF A MCDPS ACCESS PERMIT

CLIENT: OMER.

#### **MONTGOMERY COUNTY** MARYLAND DEPARTMENT OF GENERAL SERVICES

OFFICE OF PLANNING AND DEVELOPMENT 101 MONROE STREET, 11TH FLOOR ROCKVILLE, MARYLAND 20850

PROJECT:

Olney Library Addition & **Renovation Design** 

Development 3500 Olney-Laytonsville Road Olney, Maryland 20832 PROJECT NO.: Client Proj. No.

The Lukmire Partnership, Inc. Architecture Planning Interiors



2700 S. QUINCY STREET ARLINGTON, VA 22206 T: 703-998-01014 F: 703-998-7798 www.lukmire.com

& LANDSCAPE ARCHITECTURE Patrick East Business Center 97 Monocacy Blvd., Unit H Frederick, Maryland 21701 Phone: 301-662-4408 Fax: 301-662-7484 www.adtekengineers.com

REGISTRATION:

NO. DATE ISSUE DESCRIPTION 1 | 12-11-2009 | Mandatory Referral

13210

A/E PROJECT NO: DRAWN BY: CHECKED BY: KEY PLAN:

LYV


SPB

STORMWATER PLANTING



SHEET TITLE:

SHEET NUMBER:

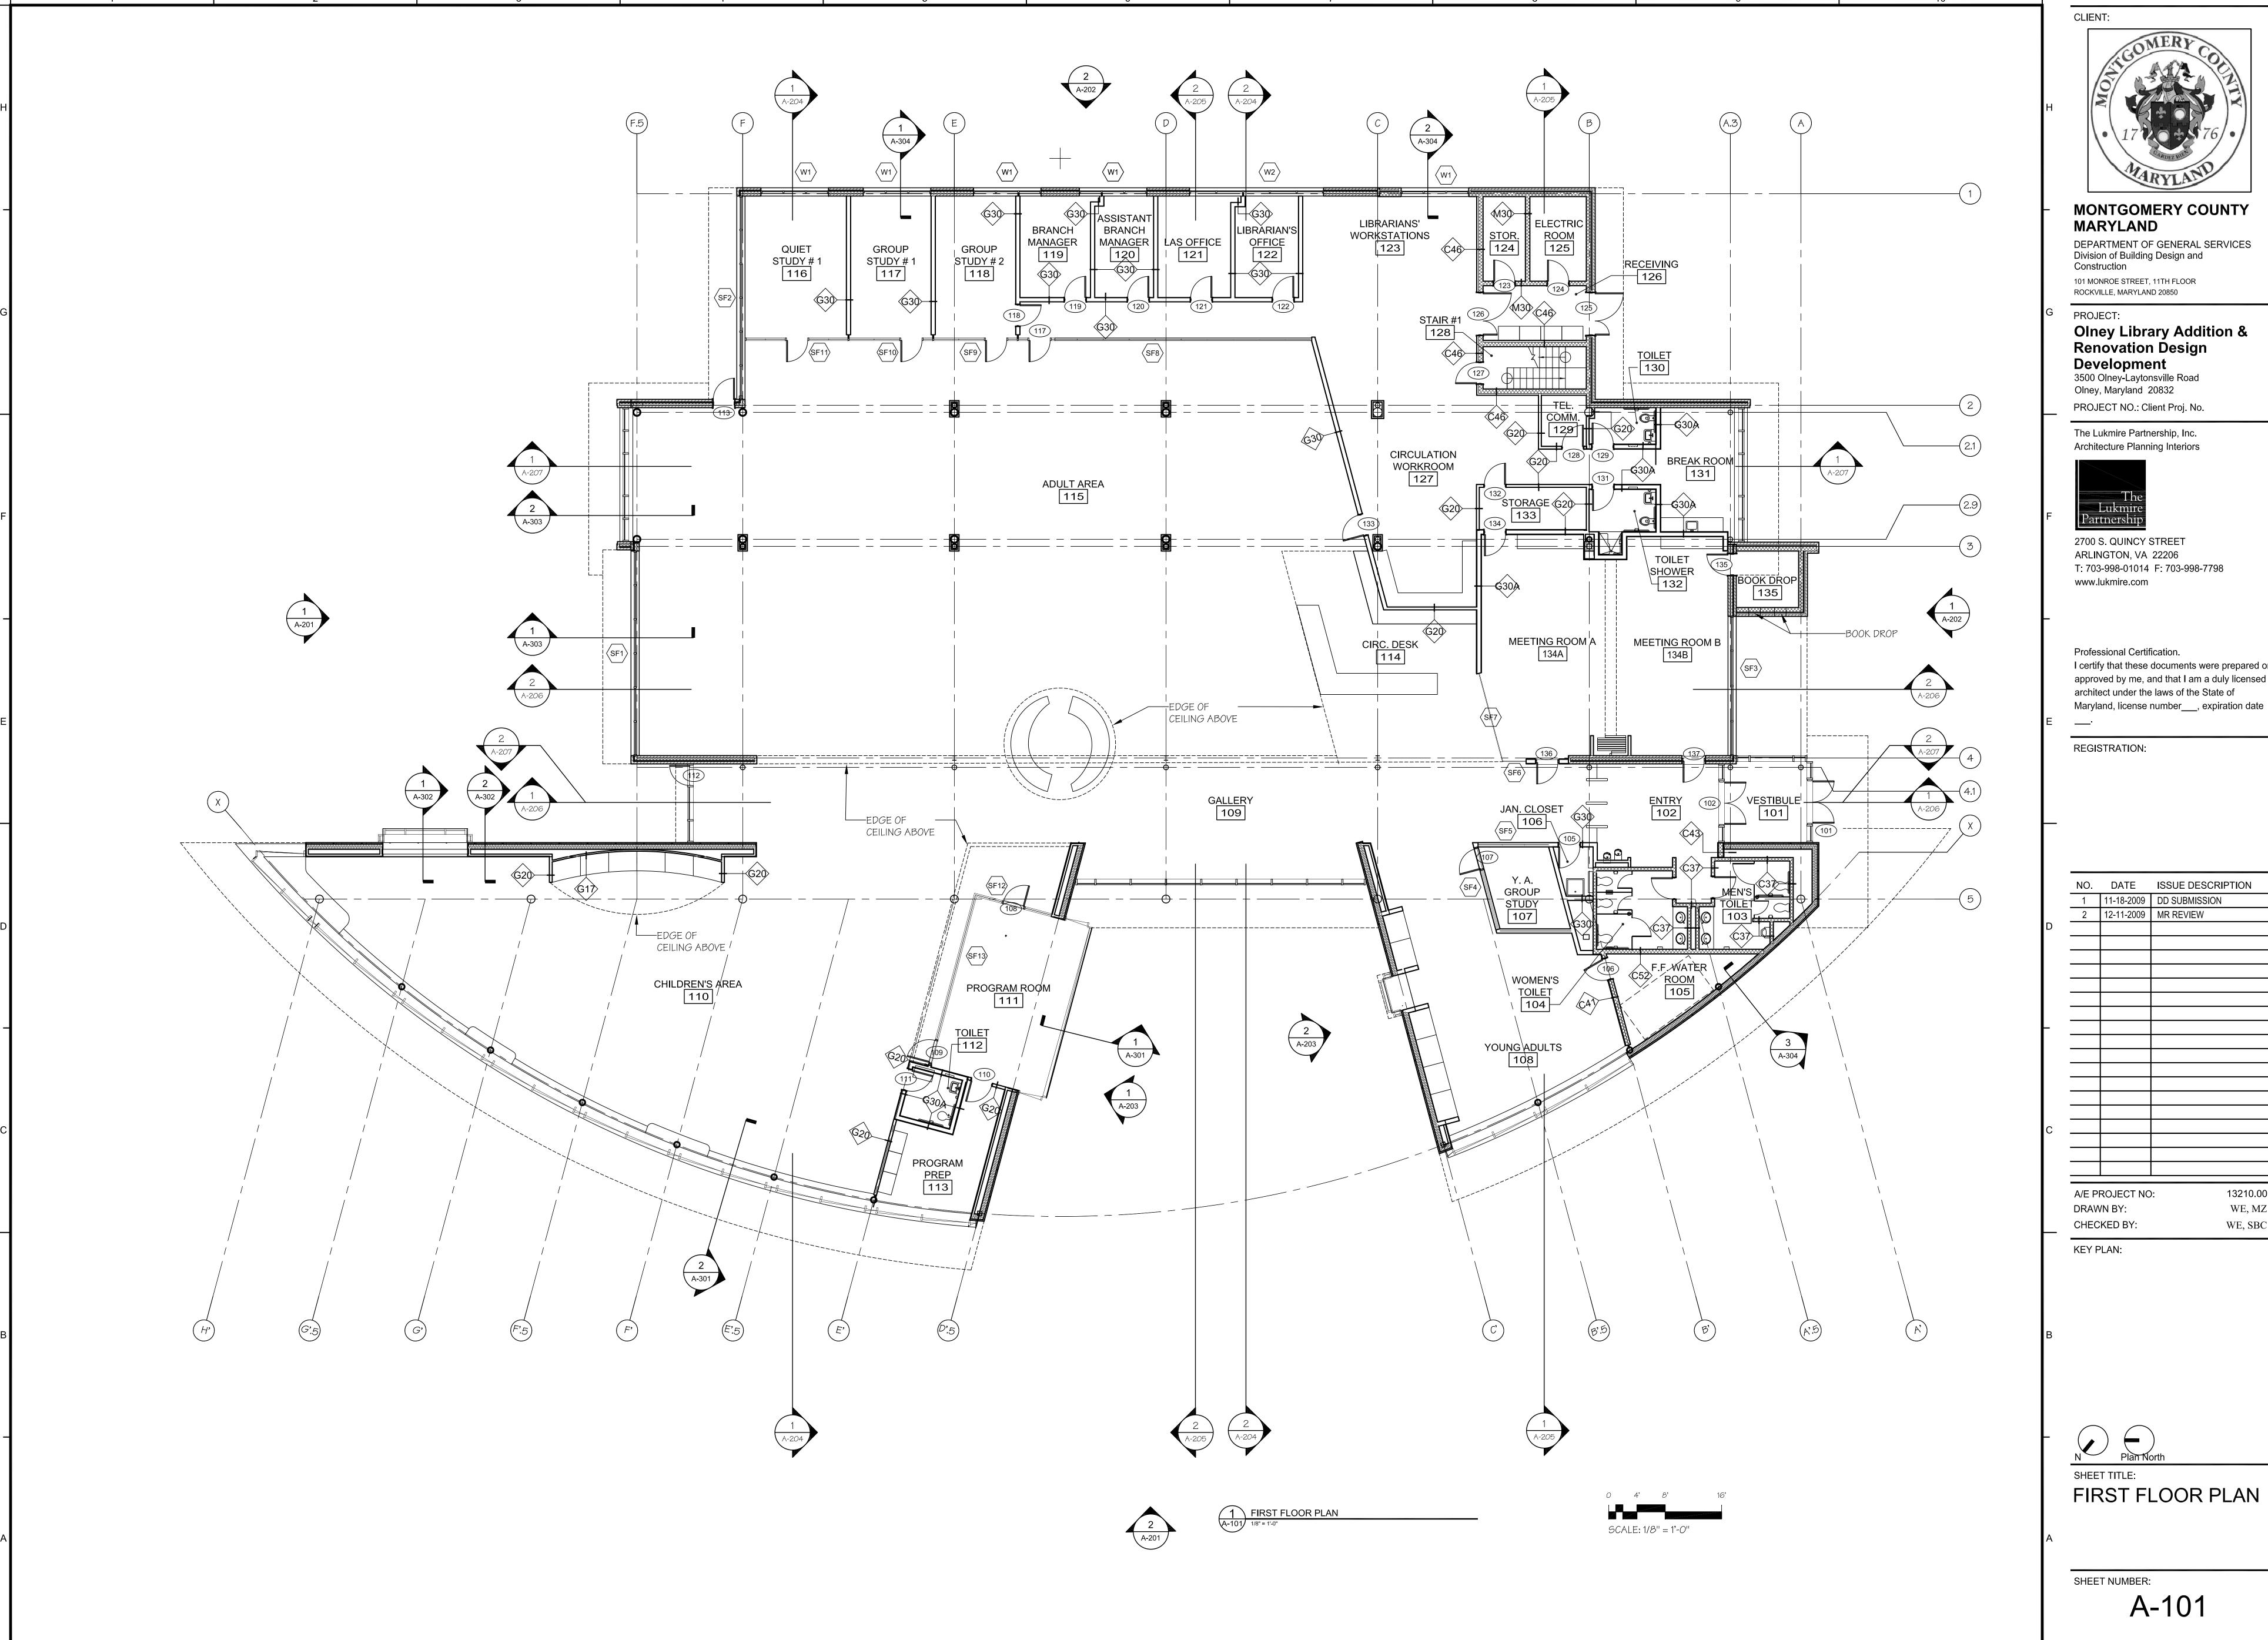


### **MONTGOMERY COUNTY**


DEPARTMENT OF GENERAL SERVICES
Division of Building Design and
Construction

T: 703-998-01014 F: 703-998-7798


I certify that these documents were prepared or approved by me, and that I am a duly licensed architect under the laws of the State of Maryland, license number\_\_\_, expiration date


NO.	DATE	ISSUE DESCRIPTION
1	11-18-2009	DD SUBMISSION
2	12-11-2009	MR REVIEW
A/E P	ROJECT NO	): 13210.00
DRAW	/N BY:	WE, MZ
CHEC	KED BY:	WE, SBC
VEV D	Ν. Α.Ν.	

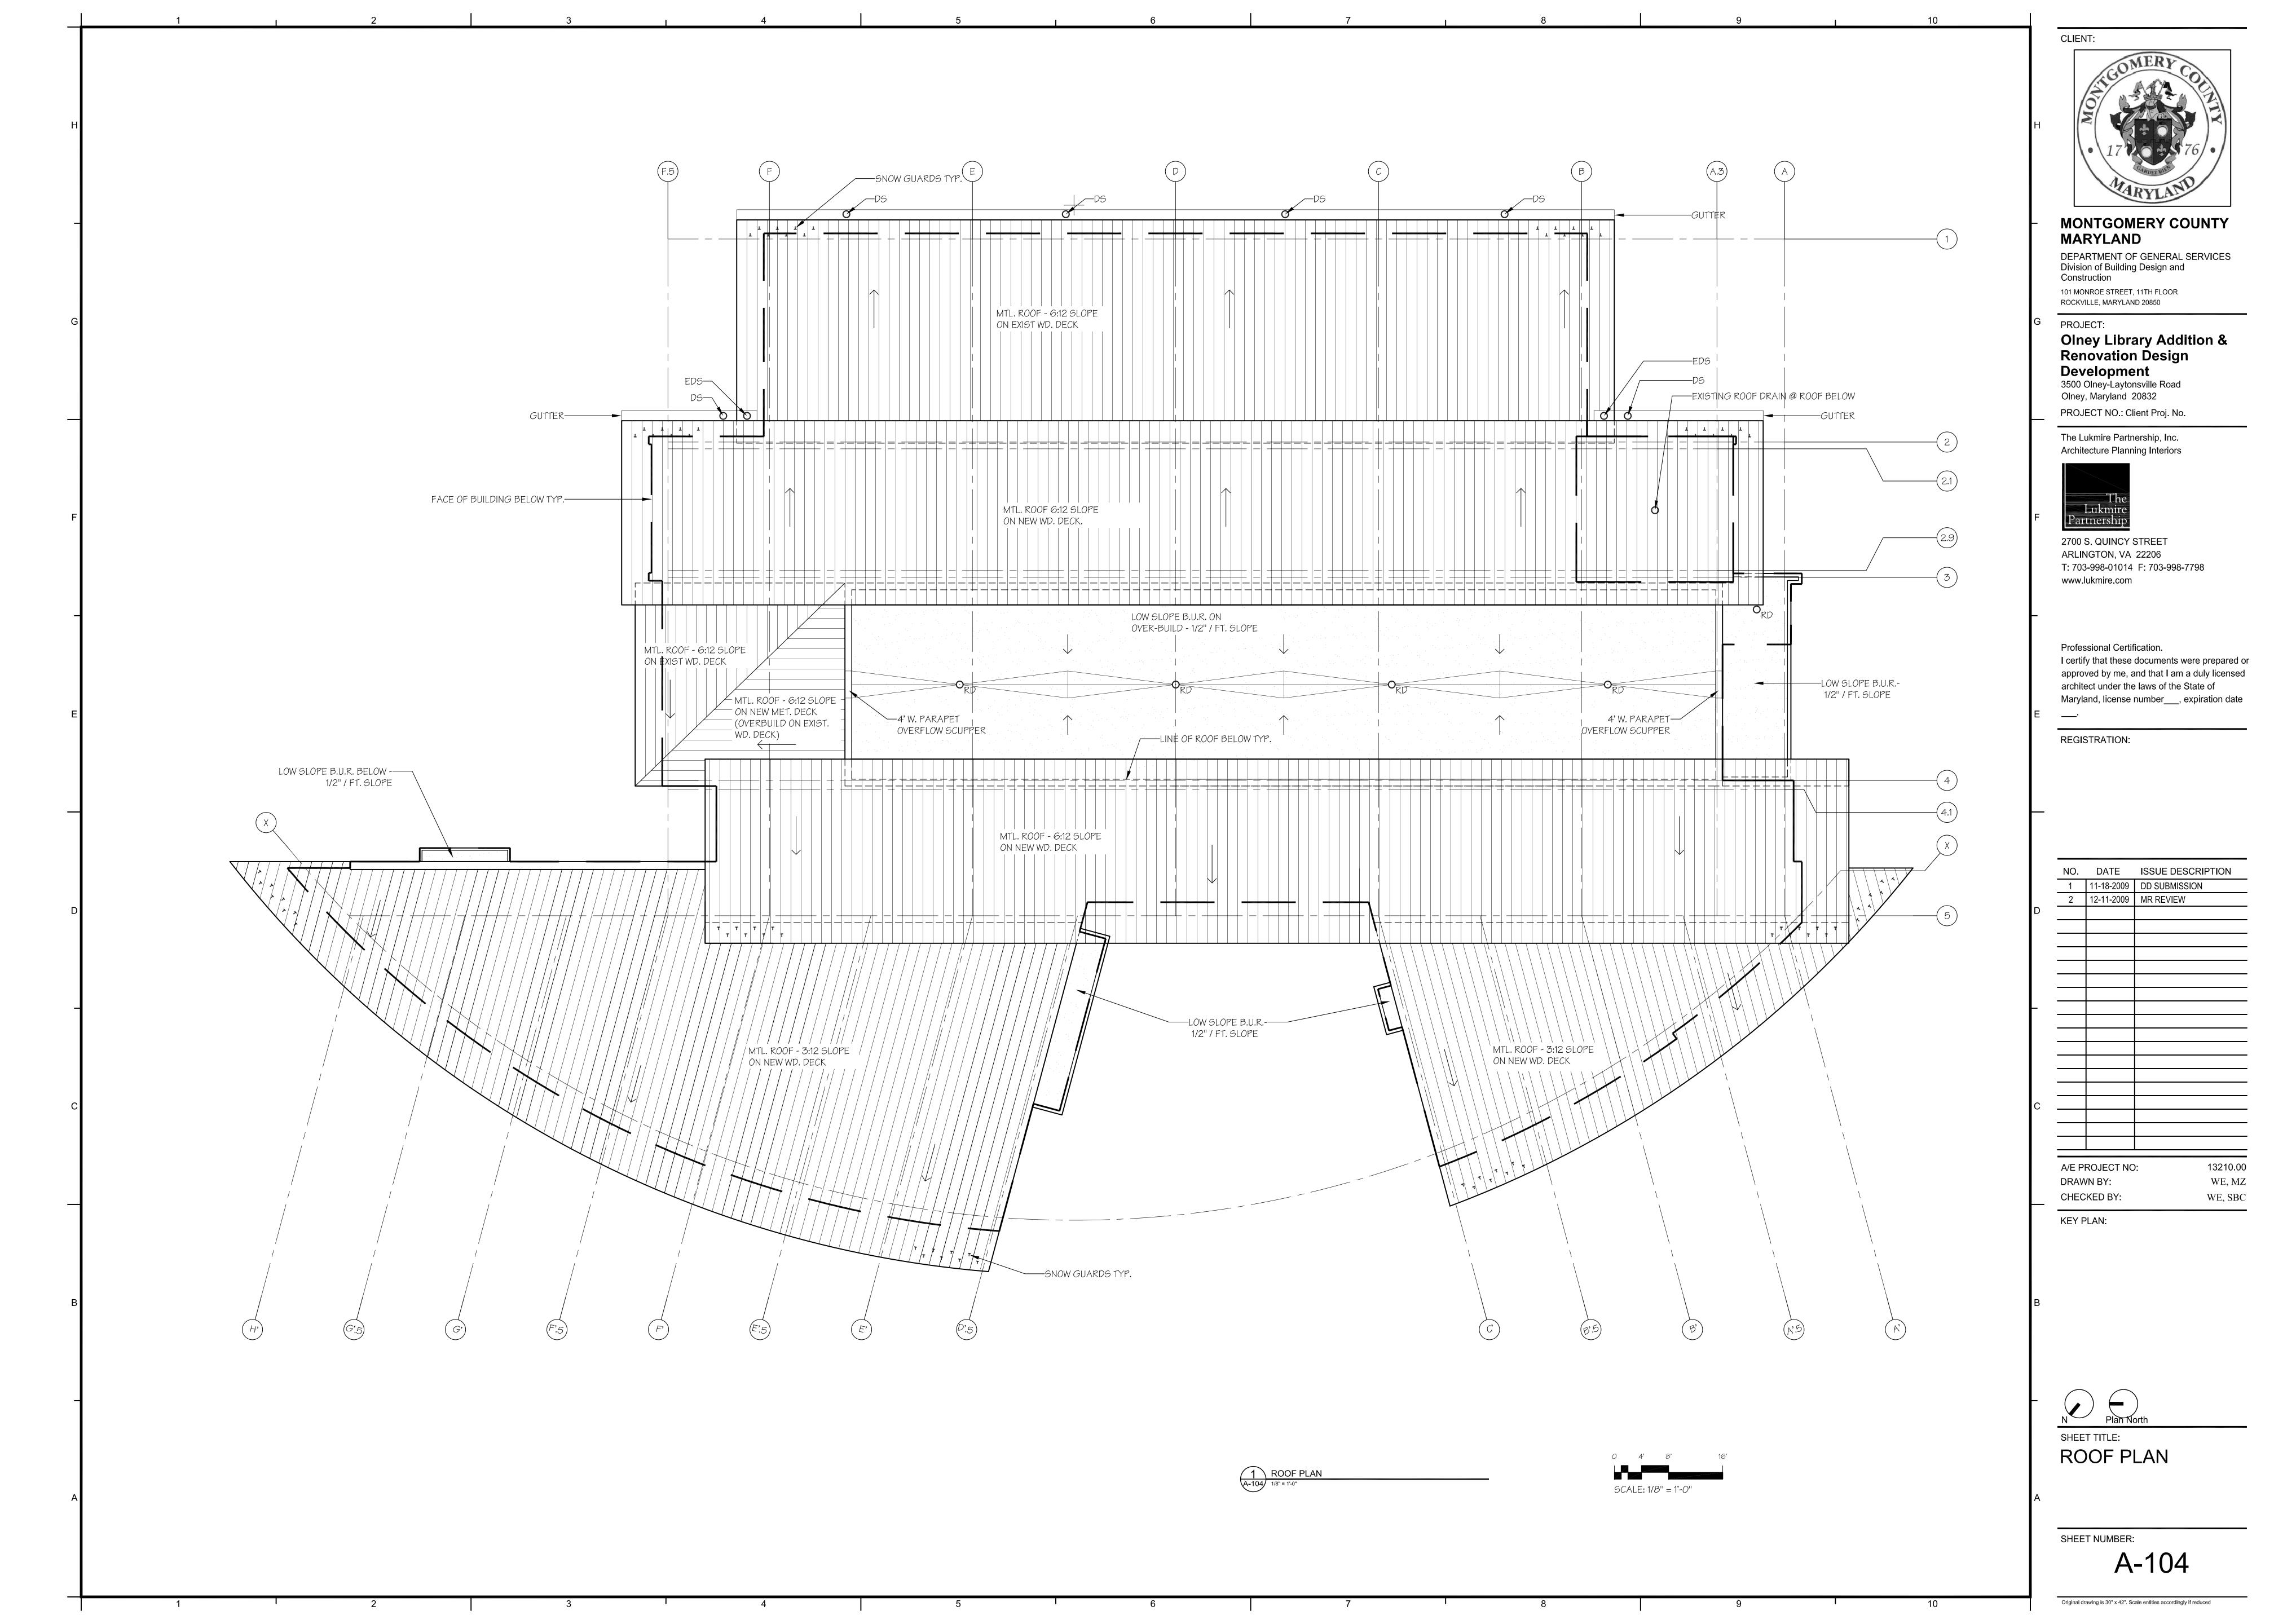

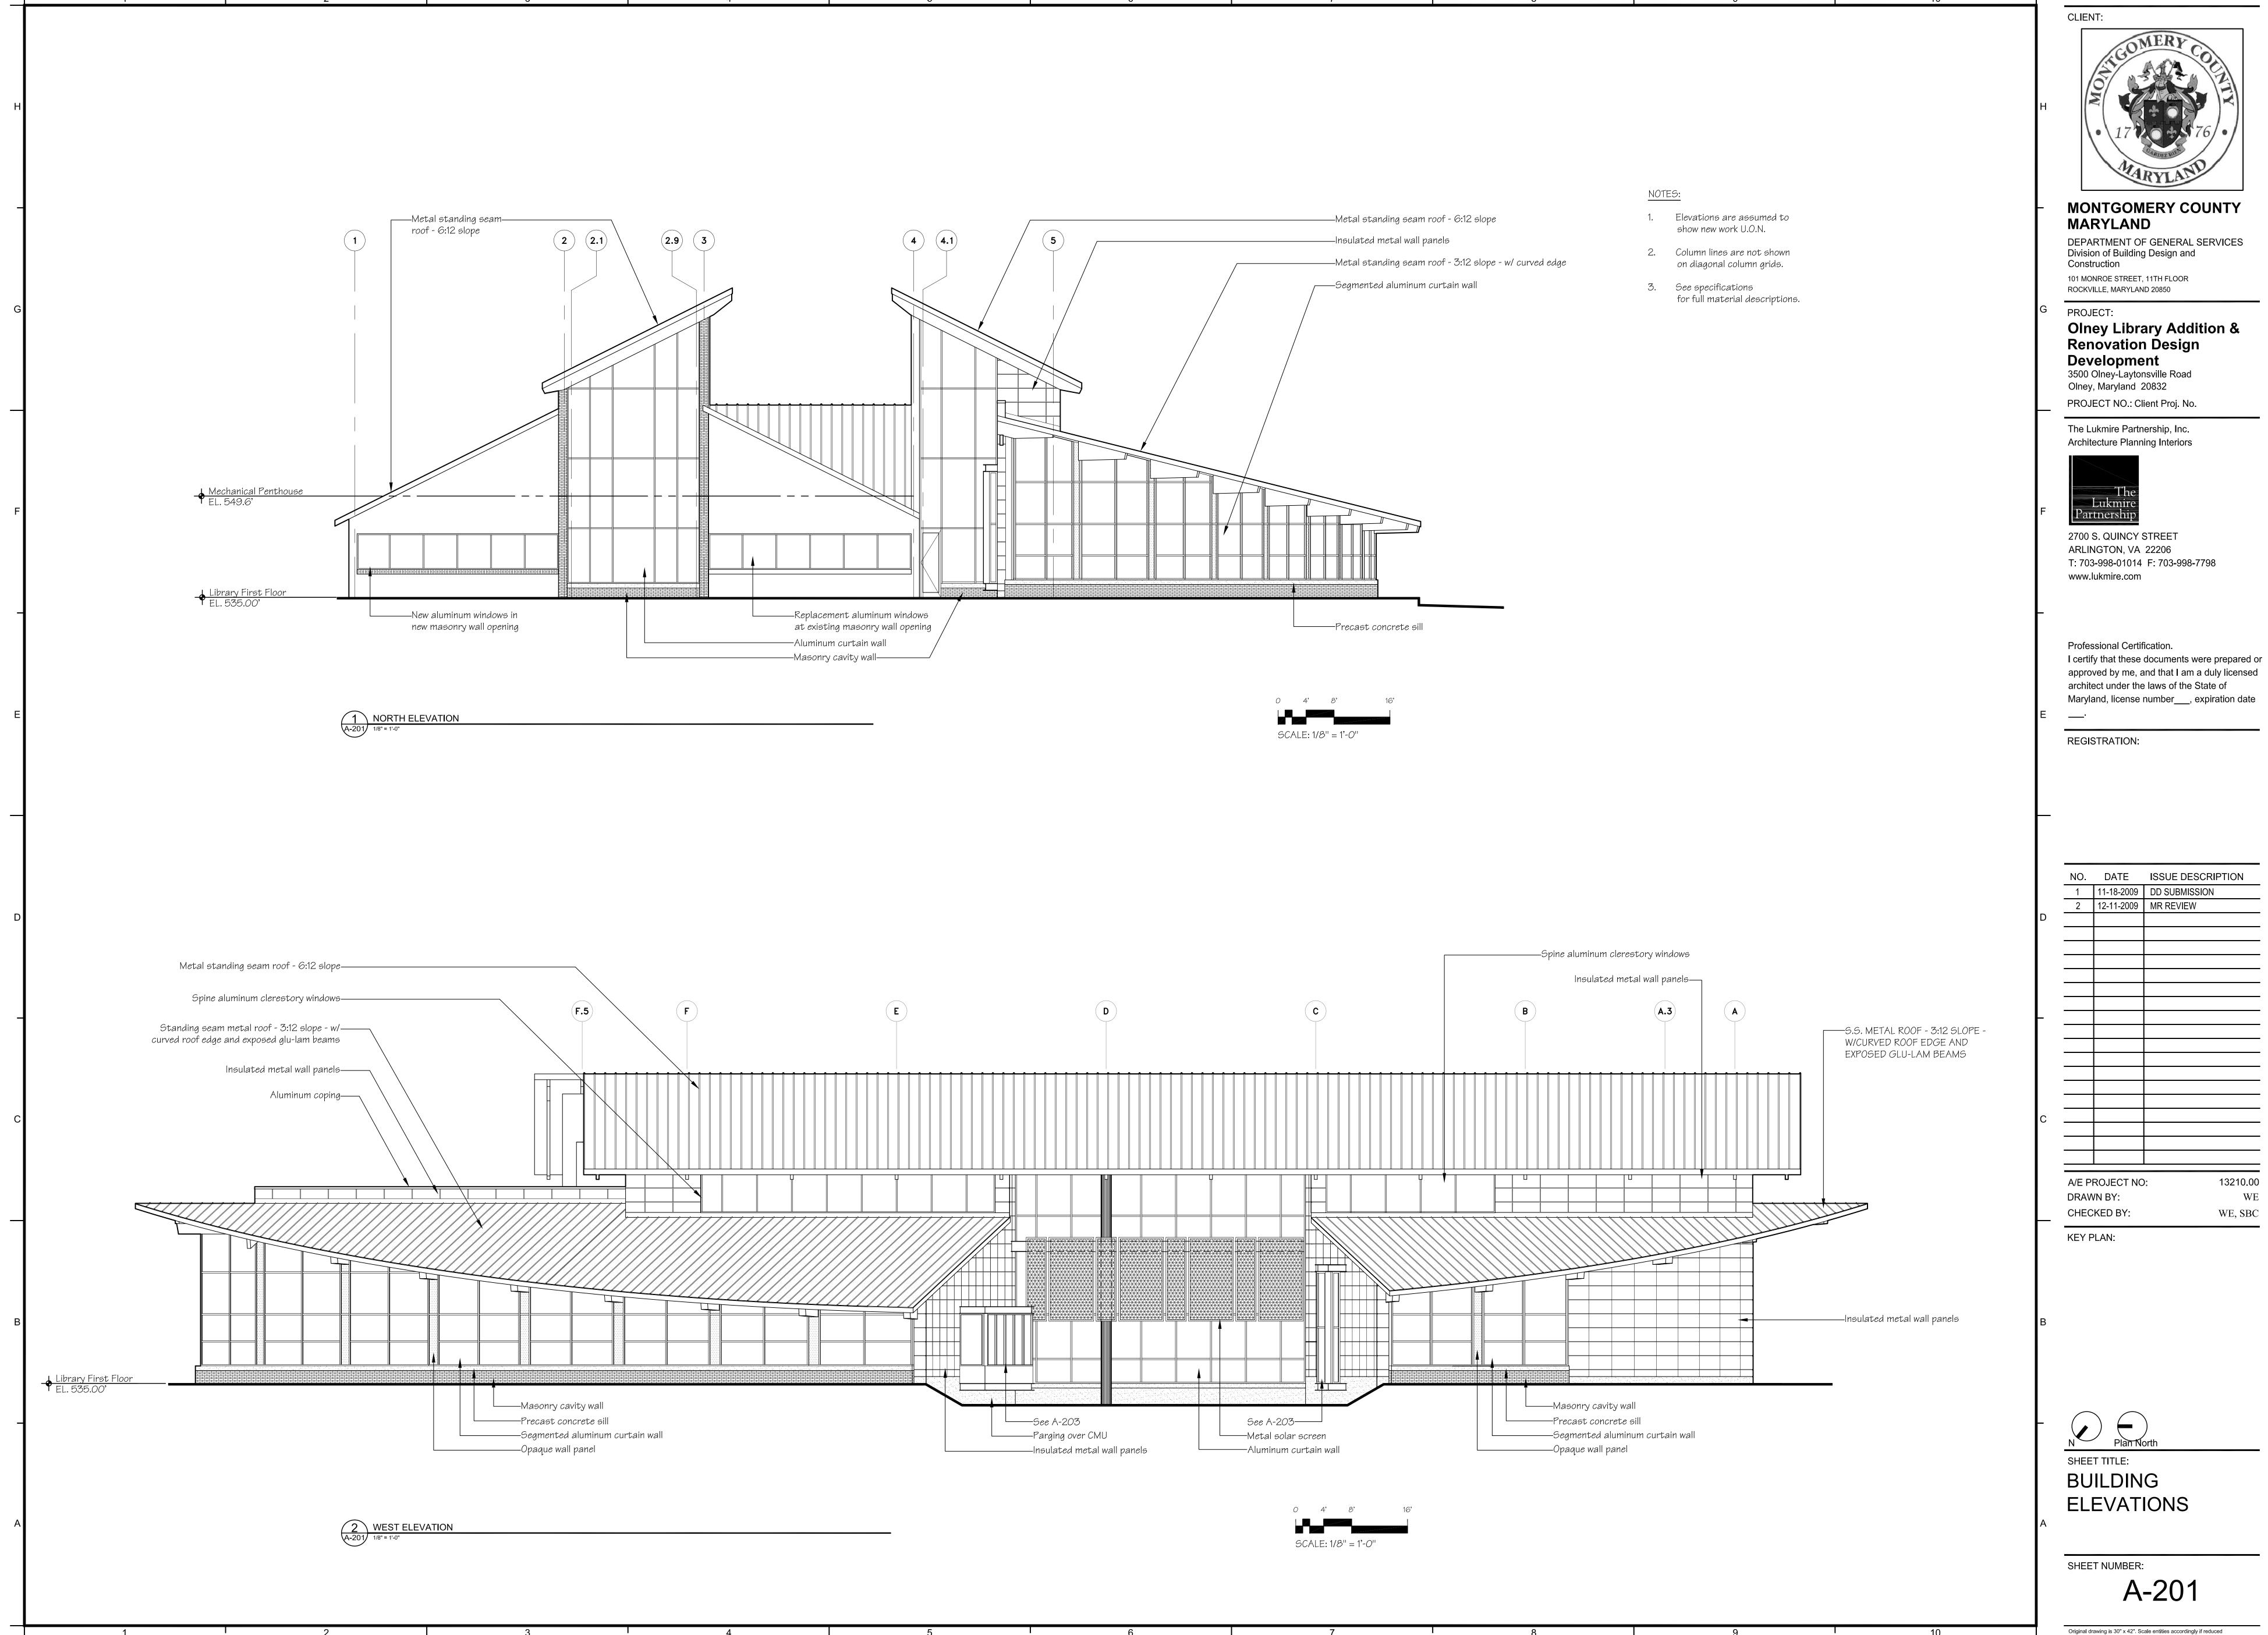


NO.	DATE	ISSUE DESCRIPTION
1	11-18-2009	DD SUBMISSION
2	12-11-2009	MR REVIEW
	ROJECT NO	
DRAV	VN BY:	WE
CHEC	KED BY:	WE, SBC
KEY F	PI AN:	
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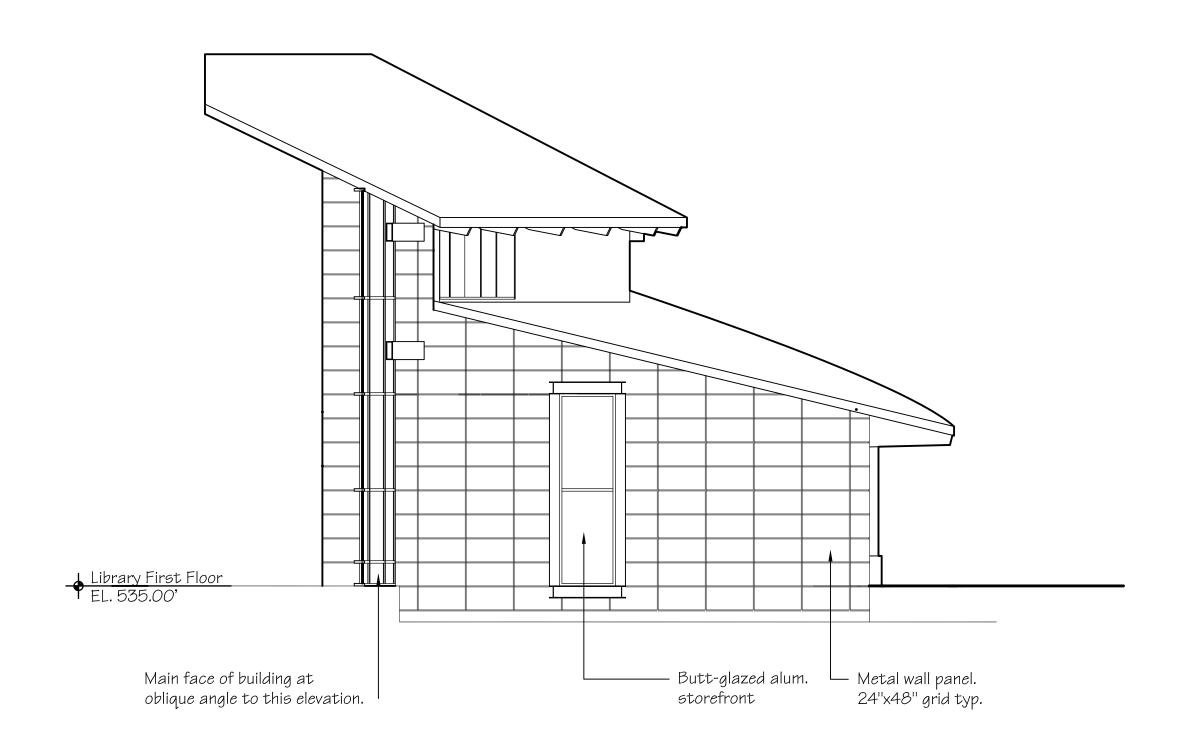


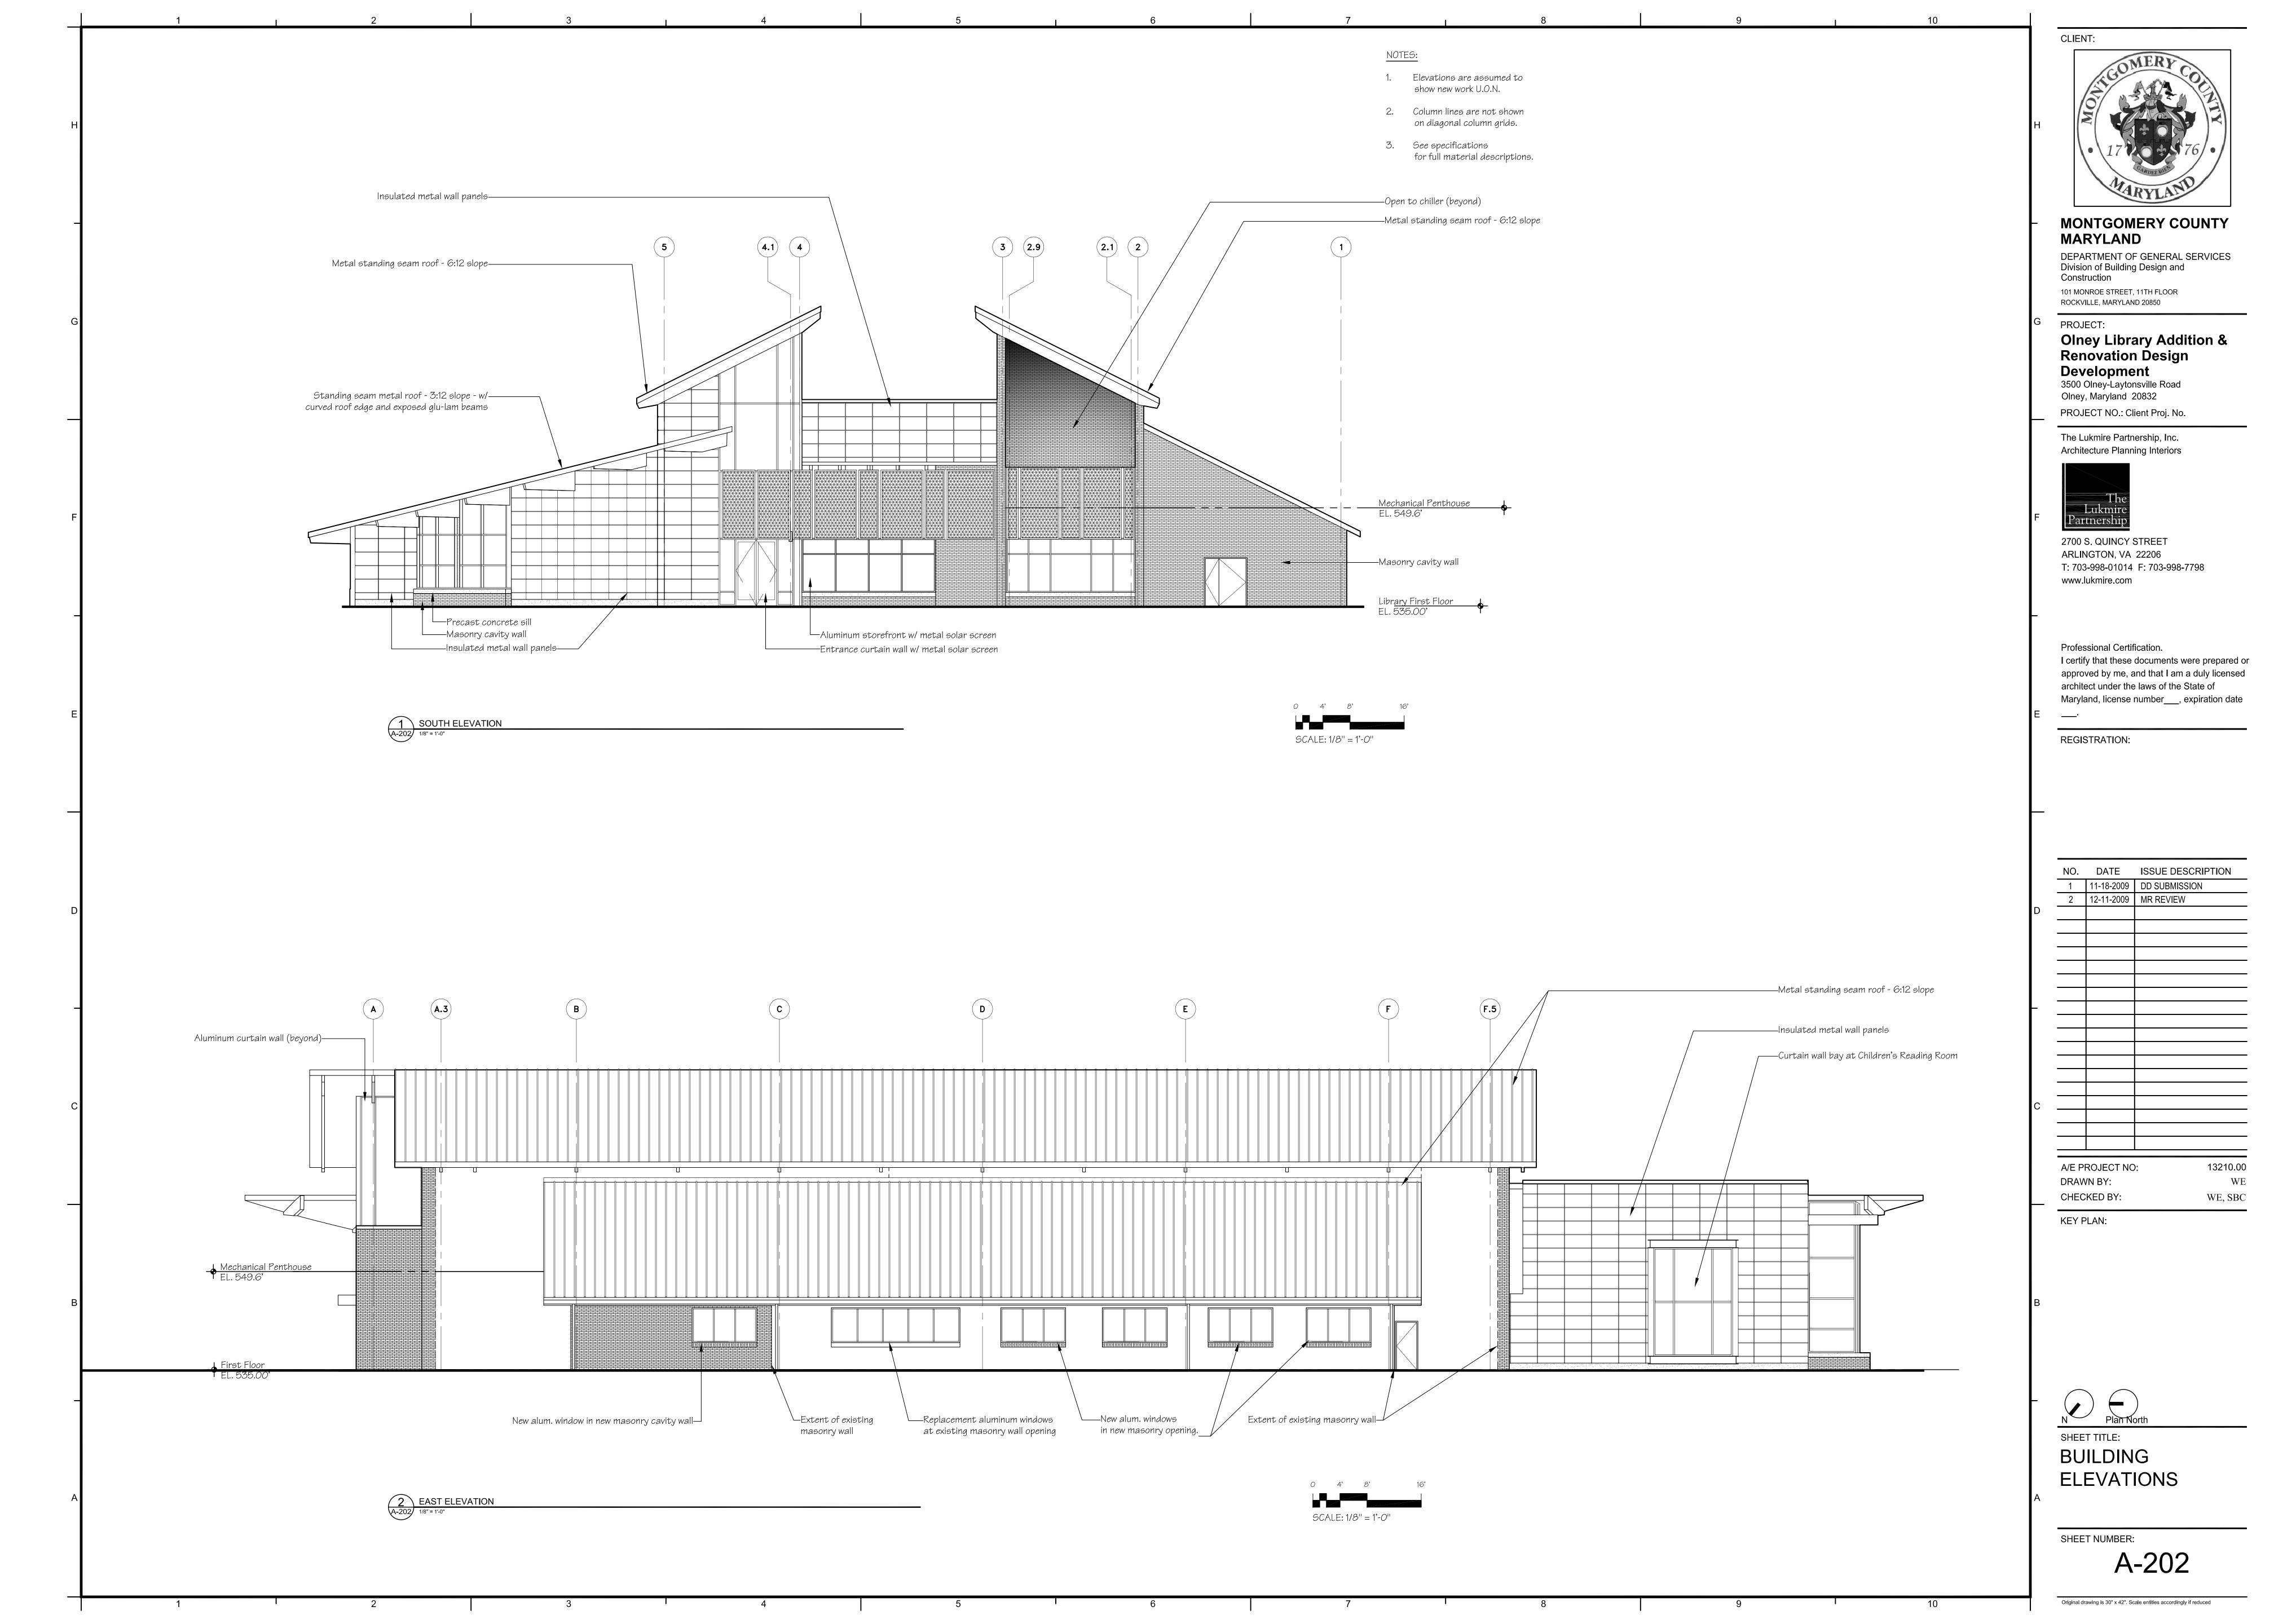


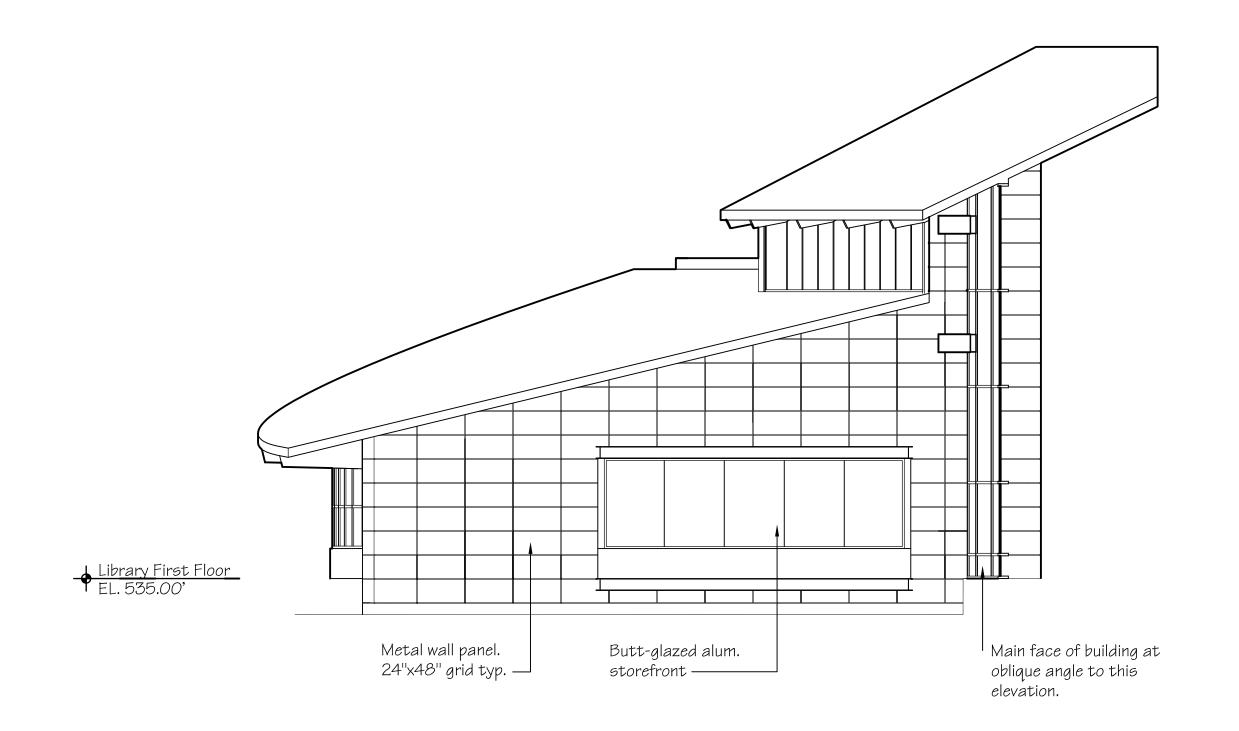SOUTHWEST ELEVATION


A-203 1/8" = 1'-0"



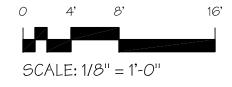

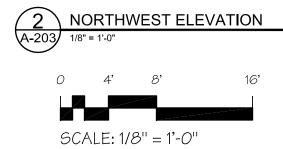



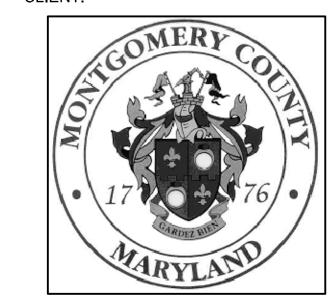

#### **MONTGOMERY COUNTY MARYLAND**

DEPARTMENT OF GENERAL SERVICES Division of Building Design and Construction

101 MONROE STREET, 11TH FLOOR ROCKVILLE, MARYLAND 20850

PROJECT: Olney Library Addition & Renovation Design

**Development** 3500 Olney-Laytonsville Road Olney, Maryland 20832 PROJECT NO.: Client Proj. No.

The Lukmire Partnership, Inc. Architecture Planning Interiors



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Professional Certification. I certify that these documents were prepared or approved by me, and that I am a duly licensed architect under the laws of the State of Maryland, license number\_\_\_, expiration date

**REGISTRATION:** 


	NO.	DATE	ISSUE DESCRIPTION
	1	11-18-2009	DD SUBMISSION
	2	12-11-2009	MR REVIEW
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С			
	A/E PI	ROJECT NC	); 13210.00
		/N BY:	WE
		KED BY:	WE, SBC
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	KEY F	PLAN:	

N	Plan North			
SHEET TITLE:				


BUILDING **ELEVATIONS** 

SHEET NUMBER:

A-203

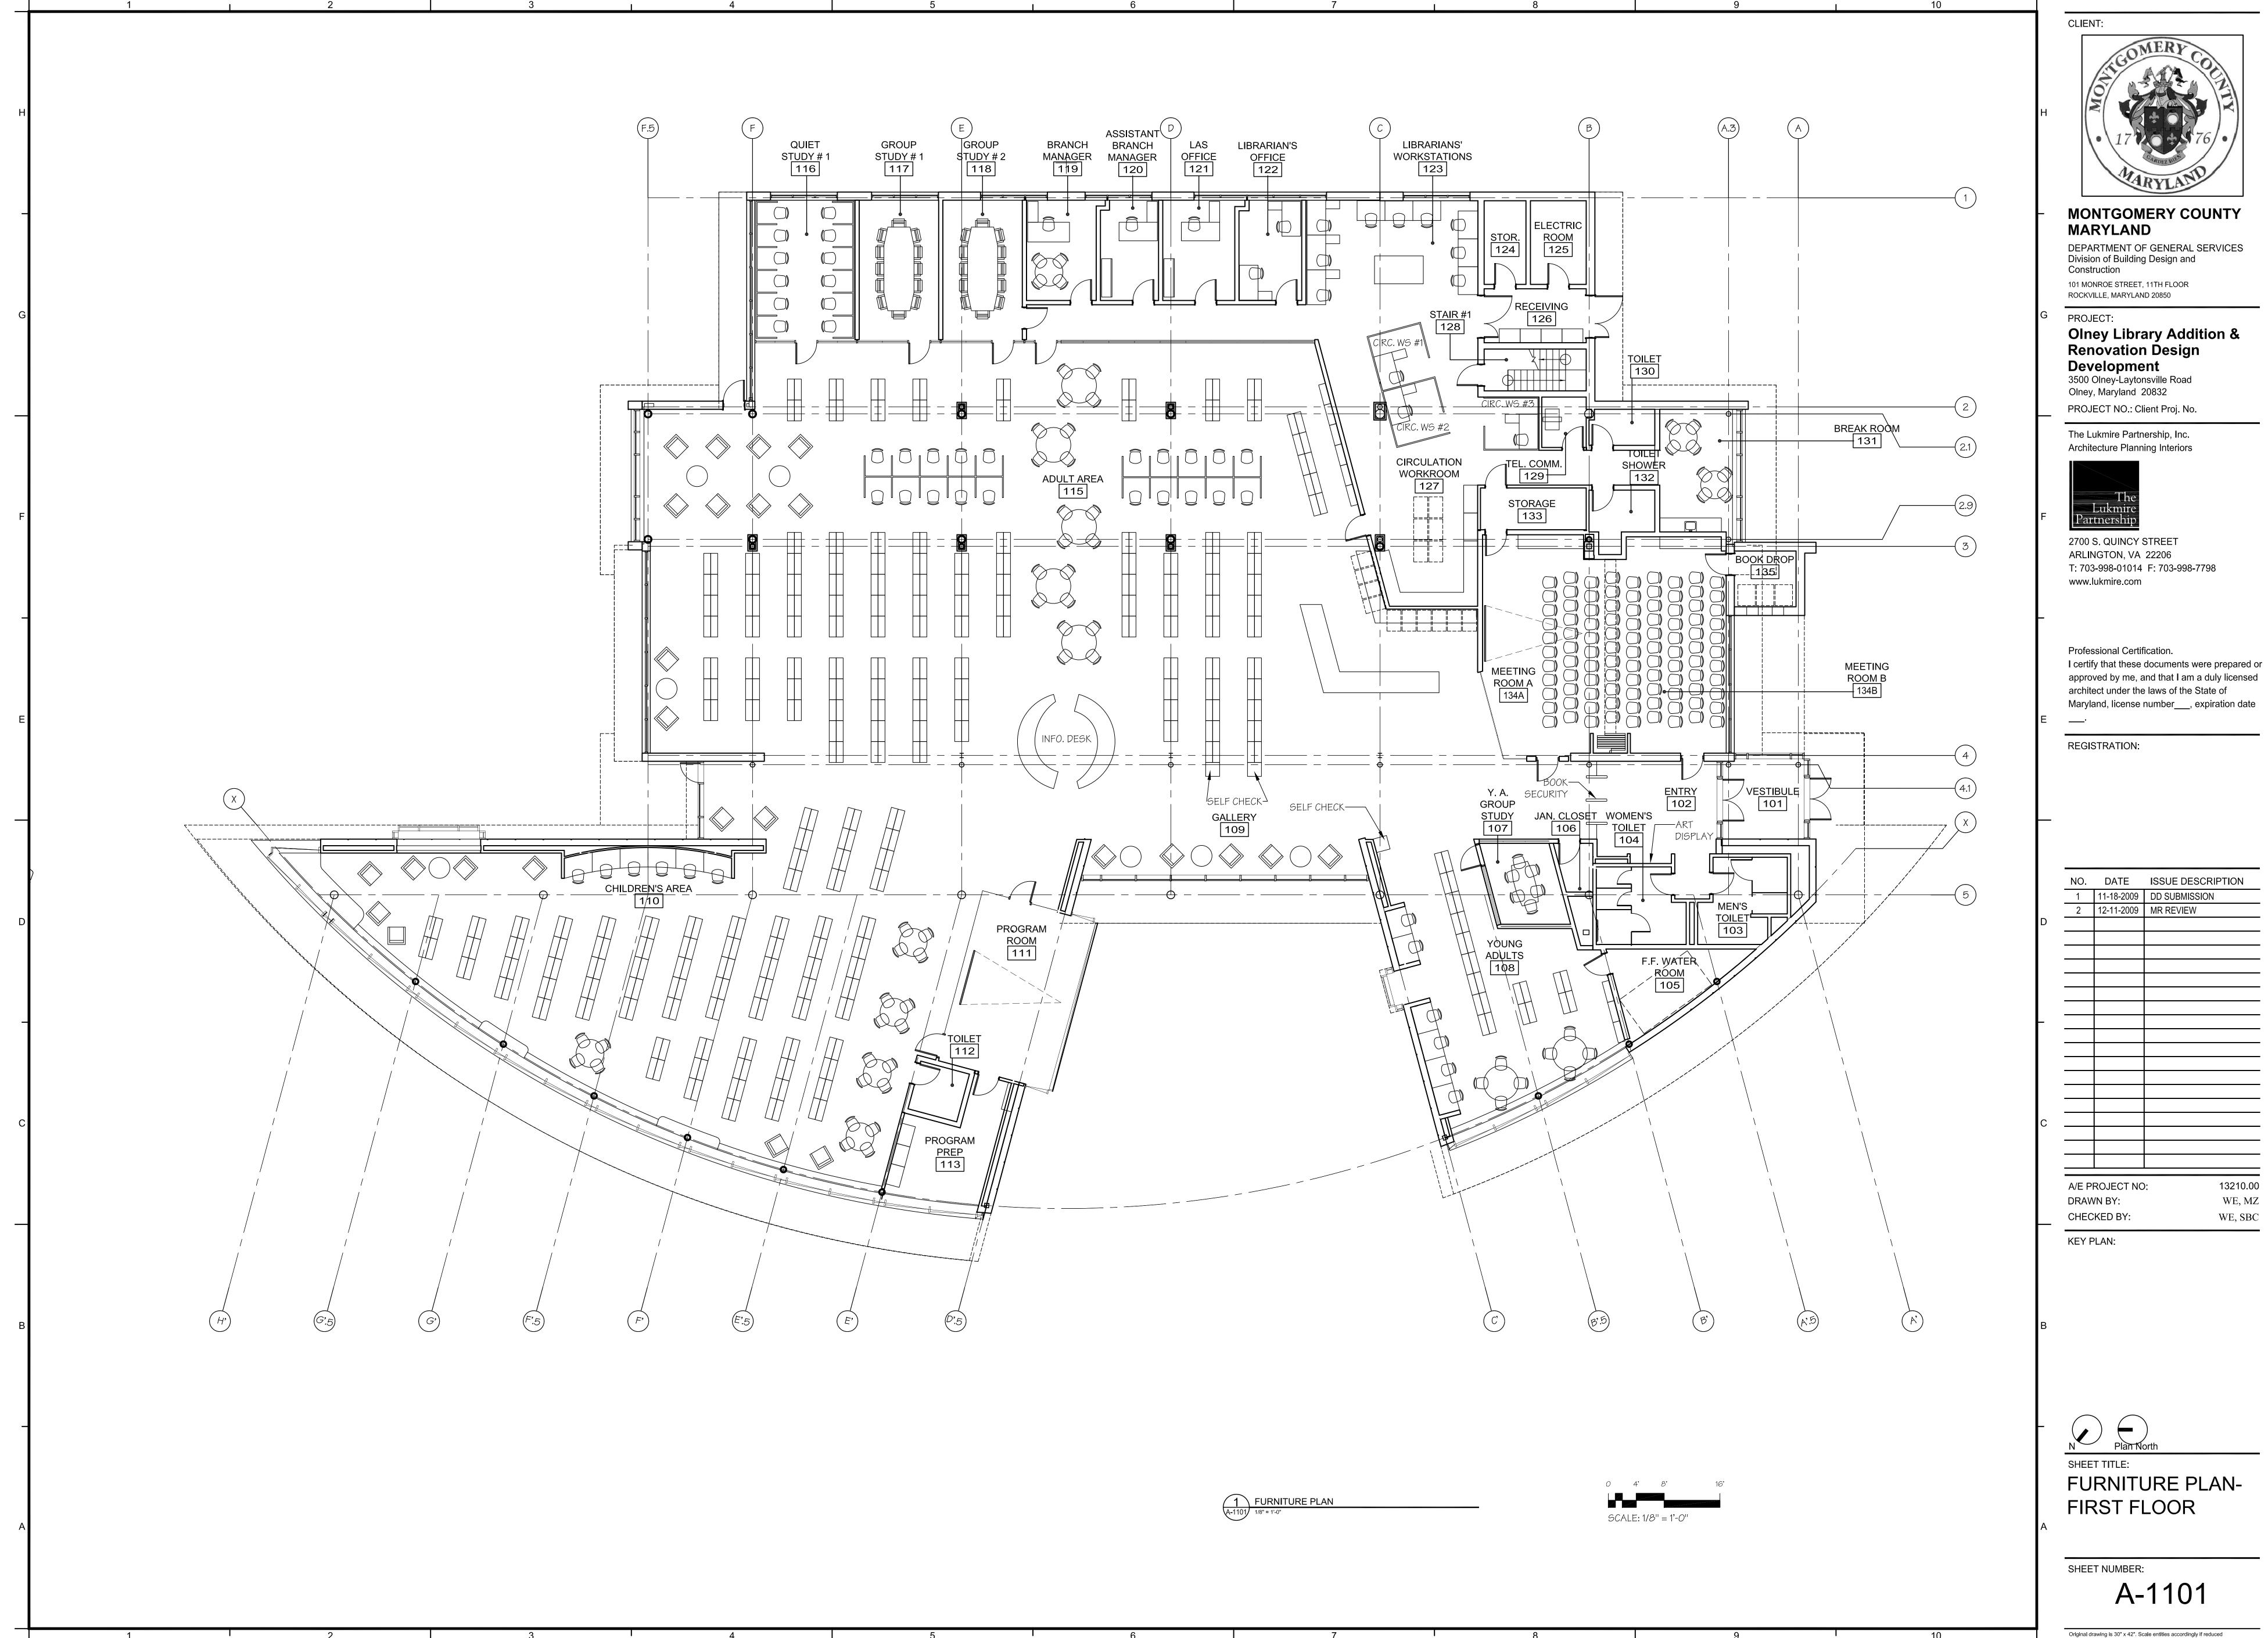

NO.	DATE	ISSUE DESCRIPTION
1	11-18-2009	DD SUBMISSION
2	12-11-2009	MR REVIEW
		40040.00
A/E PROJECT NO		
DRAV	VN BY:	WE, MZ
CHECKED BY:		WE, SBC
KEY PI AN:		

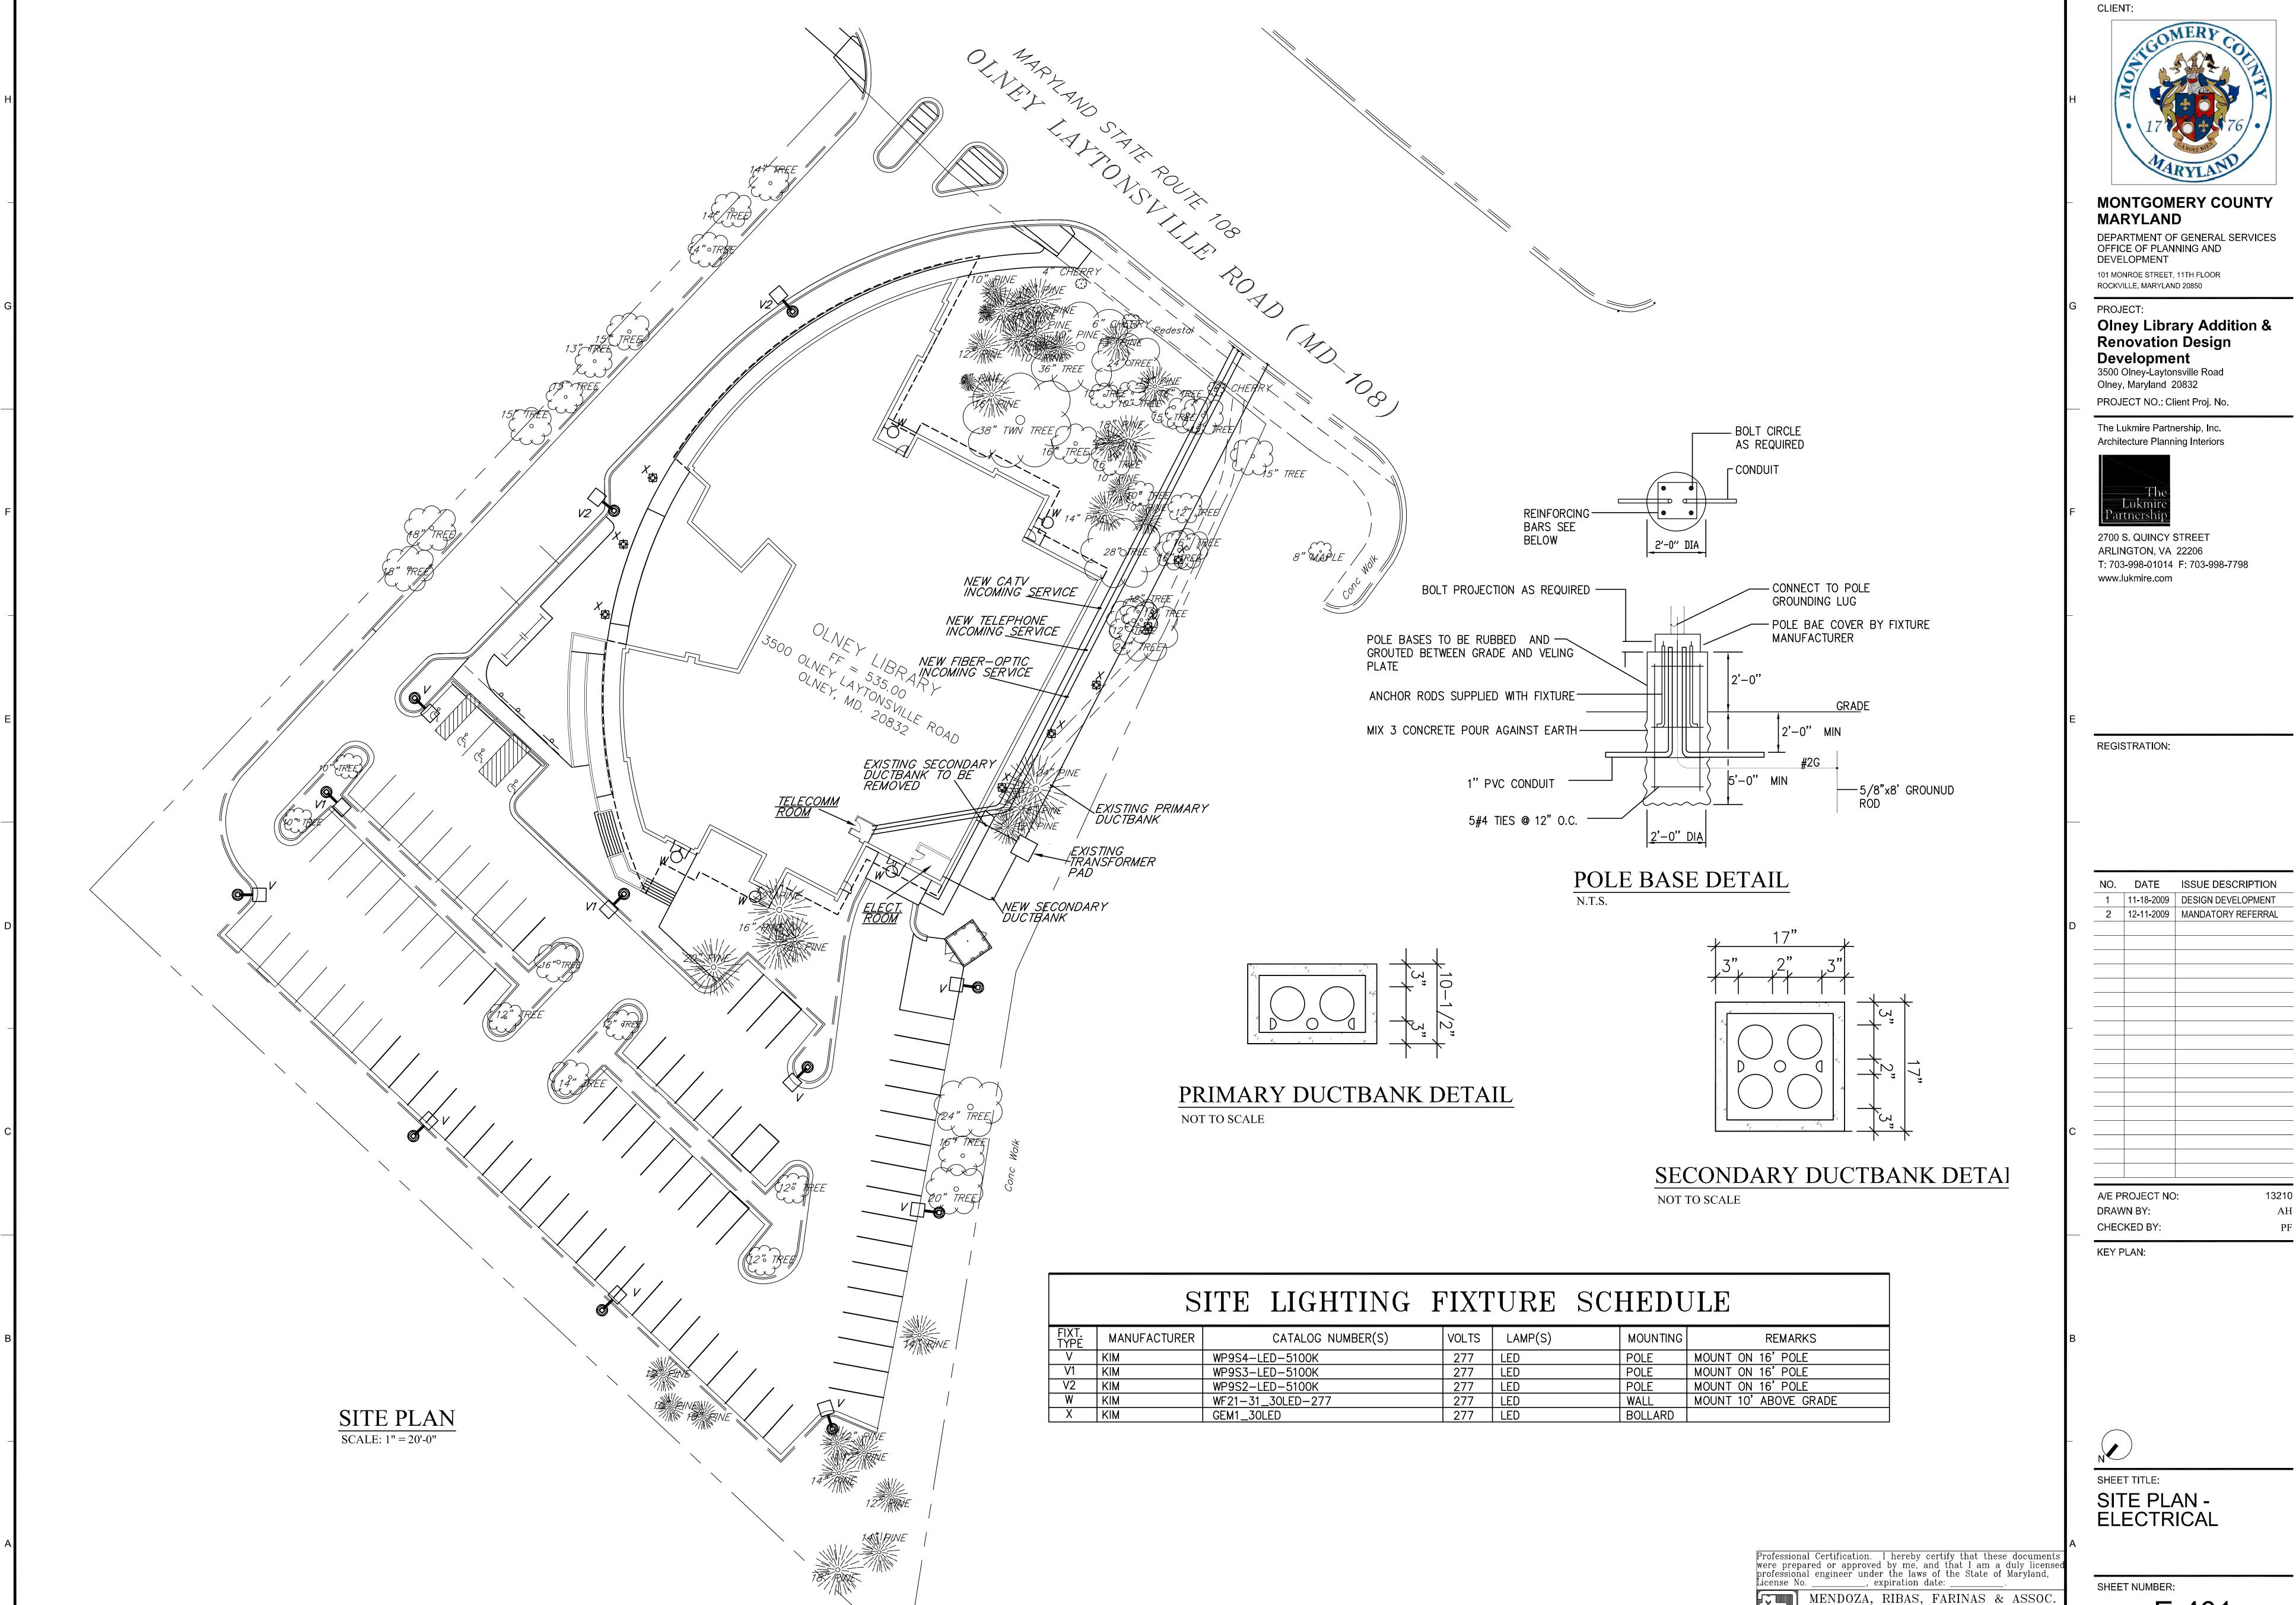

E-401

CONSULTING ENGINEERS
6265 Executive Boulevard, Rockville, Maryland 20852
(T)(301) 468-8882 (F)(301)770-2567 (E)MRF@MRF-A.Com



1	11-18-2009	DESIGN DEVELOPMENT	
2	12-11-2009	MANDATORY REFERRAL	
YE PI	13210		